F.D. FLOOR DRAIN

FDN. FOUNDATION

FINISH

FLUOR. FLOURESCENT

F.O. FACE OF

GA. GAUGE

GALV. GALVANIZED

H.B. HOSE BIB

HDR. HEADER

INT. INTERIOR

JST. JOIST

JT. JOINT

LT. LIGHT

L.H. LEFT HAND

L/S LANDSCAPE

FIN.

FTG.

GFRG

INCL.

INSUL.

MEMB.

MTL.

MFR.

MTD.

O.A.

O.C.

OPG.

P-LAM

PROP.

PLY.

РΤ

R.D.

REC.

REG.

REINF.

REQ'D

R.H.R.

R.W.L.

S.D.

SIM.

S.S.D.

SQ.

T&G

TBD

TEMP.

THK.

T.O.C.

T.O.W.

UHMW

W.H.

W.P.

WIN.

W/O

W.W.M.

TYP.

RWD.

REV.

R.H.

OPP.

OP.

FL./ FLR. FLOOR

F.G. FIXED GLAZING

FOOTING

G.B. GYPSUM BOARD

GALVANIZED IRON

HOLLOW CORE

HOLDDOWN

INCLUDE(D)

INSULATION

L.H.R. LEFT HAND REVERSE

MAXIMUM

MEMBRANE

MINIMUM

MOUNTED

N.I.C. NOT IN CONTRACT

OVERALL

ON CENTER

OPERABLE

OPENING

OPPOSITE

PLYWOOD

PROPERTY

RE-LOCATE(D)

ROOF DRAIN

RECESSED

REINFORCED

REGISTER

REQUIRED

REVERSE

RIGHT HAND

REDWOOD

S.C. SOLID CORE

SHT'G SHEATHING

SIMILAR

SQUARE

TREAD

THICK

TYPICAL

W.C. WATER CLOSET

WINDOW

WITHOUT

WOOD

TEMPERED

TOP OF CURB

TOP OF WALL

RIGHT HAND REVERSE

RAINWATER LEADER

SMOKE DETECTOR

TONGUE & GROOVE

TO BE DETERMINED

U.O.N. UNLESS OTHERWISE NOTED

POLY-ETHELENE

WATERHEATER

WELDED WIRE MESH

WATERPROOF

ULTRA HIGH MOLECULAR WEIGHT

SEE STRUCTURAL DRAWINGS

RISER

PLASTIC LAMINATE

PRESSURE-TREATED

MANUFACTURER

M.B. MACHINE BOLT

METAL

NEW

N.T.S. NOT TO SCALE

MECH. MECHANICAL

HEIGHT

GLUE-LAMINATED BEAM

GALVANIZED SHEET METAL

GLASS FIBER REINFORCED GYPSUM

LOCATION MAP (N.T.S) **ABBREVIATIONS** A.B. ANCHOR BOLT FIRE HYDRANT A/C AIR CONDITION ABOVE FINISHED FLOOR A.F.F. APP APPROVED ARCH. ARCHITECT ARCH'L ARCHITECTURAL BD. BOARD BLDG. BUILDING BLK'G BLOCKING BFAM B.O. BY OWNER BOT. BOTTOM B.O.W. BASE OF WALL B.U. BUILT-UP A Carriage CENTERLINE CLR. CLEAR CLG. CEILING COL. COLUMN CSK COUNTERSIN South San Francisc COMP. COMPOSITION CONC. CONCRETE CONT. CONTINUOUS CONTR. CONTRACTOR COLD-ROLLED CHANNEL Burkhardt Manufacturin C.T. CERAMIC TILE DOUBLE DET. DETAIL DWR. DRAWER DIMENSION EACH ELEV. ELEVATION EQ. EQUAL EXHAUST EXP. EXPANSION EXT. EXTERIOR F.A. FLOOR AREA

SANITARY FACILITIES

SANITARY FACILITIES SHALL COMPLY TO CBC SECTION 11B-404 AND 11B-604 11B-605, 11B-606 AND FIGURE 11A-9A-a

(E) FIRE RISER

- A. WATER CLOSET COMPARTMENTS SHALL BE EQUIPPED WITH A DOOR THAT HAS AN AUTOMATIC CLOSING DEVICE, AND SHALL HAVE A CLEAR UNOBSTRUCTED OPENING WIDTH OF 32-INCHES WHEN LOCATED AT THE END AND 34-INCHES WHEN LOCATED AT THE SIDE WITH THE DOOR POSITION AT AN ANGLE OF 90 DEGREES FROM ITS CLOSED POSITION
- B. TOILET FLUSH CONTROLS SHALL BE OPERABLE WITH ONE HAND, AND SHALL NOT REQUIRE TIGHT GRASPING, PINCHING, OR TWISTING OF THE WRIST. CONTROLS FOR FLUSH VALVES SHALL BE MOUNTED ON THE WIDE SIDE OF THE TOILET AREAS, NO MORE THAN 44-INCHES ABOVE THE FLOOR. THE FORCE REQUIRED TO ACTIVATE CONTROLS SHALL BE NO GREATER THAN 5 POUNDS MAX.
- C. WHERE URINALS ARE PROVIDED AT LEAST ONE WITH A RIM PROJECTING A MINIMUM OF 14-INCHES FROM THE WALL AND AT A MAXIMUM OF 17-INCHES ABOVE THE FLOOR SHALL BE PROVIDED
- D. URINAL FLUSH CONTROLS SHALL BE OPERABLE WITH ONE HAND, AND SHALL NOT REQUIRE TIGHT GRASPING, PINCHING, OR TWISTING OF THE WRIST AND SHALL BE MOUNTED NO MORE THAN 44" ABOVE THE FLOOR. THE FORCE REQUIRED TO ACTIVATE CONTROLS SHALL BE NO GREATER THAN 5 POUNDS
- E. HOT WATER AND DRAIN PIPES UNDER LAVATORIES SHALL BE INSULATED OR OTHERWISE CONFIGURED TO PROTECT AGAINST CONTACT. THERE SHALL BE NO SHARP OR ABRASIVE SURFACES UNDER LAVATORIES AND SINKS.
- F. FAUCET CONTROLS AND OPERATING MECHANISMS SHALL BE OPERABLE WITH ONE HAND AND SHALL NOT REQUIRE TIGHT GRASPING, PINCHING OR TWISTING OF THE WRIST. THE FORCE REQUIRED TO ACTIVATE CONTROLS SHALL BE NO GREATER THAN 5 POUNDS MAX. HAND-OPERATED METERING FAUCET SHALL REMAIN OPEN FOR 10 SECONDS MIN.
- G. TYPE AND ELECTRONICALLY CONTROLLED MECHANISMS ARE EXAMPLES OF ACCEPTABLE DESIGNS. SELF-CLOSING VALVES ARE ALLOWED IF THE FAUCET REMAINS OPEN FOR AT LEAST 10 SECONDS
- H. MIRRORS SHALL BE MOUNTED WITH THE BOTTOM EDGE OF THE REFLECTING SURFACE NOT MORE THAN 40-INCHES ABOVE THE FLOOR
- I. LOCATE TOWEL, SANITARY NAPKIN, AND WASTE RECEPTACLES WITH ALL OPERABLE PARTS NOT MORE THAN 40-INCHES FROM THE FLOOR
- J. TOILET TISSUE DISPENSERS SHALL COMPLY WITH SECTION 11-309.4 AND SHALL BE 7" MIN. AND 9" MAX IN FRONT OF THE WATER CLOSET MEASURE TO THE CENTER LINE OF THE DISPENSER. THE OUTLET OF DISPENSER SHALL BE BELOW THE GRAB BAR, 19" MIN ABOVE FINISH FLOOR AND SHALL NOT BE LOCATED BEHIND GRAB BAR.
- K. GRAB BARS SHALL COMPLY WITH SECTION 11B-609 AND 11-604.5, FASTENERS AND MOUNTING DEVICES SHALL BE DESIGNED FOR 250 LB. PER LINEAR FOOT LOAD
- L. GRAB BARS (SEE DETAIL 12/A-801): 1. THE DIAMETER OR WIDTH OF THE GRIPPING SURFACE OF A GRAB BAR SHALL BE 1-1/4" TO 2" OR THE SHAPE SHALL PROVIDE AN EQUIVALENT
- GRIPPING SURFACE 2. IF THE GRAB BARS ARE MOUNTED ADJACENT TO A WALL, THE SPACE BETWEEN THE WALL AND THE GRAB BARS SHALL BE 1-1/2"
- 3. A GRAB BAR AND ANY WALL OR OTHER SURFACE ADJACENT SHALL BE FREE OF ANY SHARP OR ABRASIVE ELEMENTS
- 4. GRAB BARS SHALL NOT ROTATE WITHIN THEIR FITTINGS
- 5. EDGES SHALL HAVE A MINIMUM RADIUS OF 1/8"

ACCESSIBLE TOILET COMPARTMENTS, SHALL COMPLY WITH CBC SECTION

- A. SEE TOILET ROOM FLOOR PLAN FOR H.C. TOILET STALL LOCATION B. PROVIDE BACKING IN WALL & TOILET PARTITION FOR GRAB BAR ANCHORAGE
- C. COMPARTMENT DOOR TO PROVIDE A MINIMUM 9" CLEARANCE FOR FOOTRESTS UNDERNEATH DOOR, OR A MINIMUM OF 18" SIDE-STRIKE
- CLEARANCE IS PROVIDED E. INSIDE AND OUTSIDE OF THE COMPARTMENT DOOR IS EQUIPPED WITH A
- LOOP OR U-SHAPED HANDLE IMMEDIATELY BELOW THE LATCH. THE LATCH IS A FLIP-OVER STYLE, SLIDING, OR OTHER HARDWARE NOT REQUIRING TIGHT GRASPING OR TWISTING
- F. OPENING HARDWARE IS CENTERED BETWEEN 30" AND 44" ABOVE FINISH

POSITION OF 70 DEGREES TO A POINT 3" FROM THE LATCH).

- G. TOILET PAPER DISPENSER ALLOWS CONTINUOUS PAPER FLOW AND DOES
- NOT CONTROL DELIVERY. SEE CBC SECTION 11B-604.7 H. THE ACCESSIBLE COMPARTMENT DOOR SHALL BE EQUIPPED WITH AN AUTOMATIC CLOSING DEVICE (3 SECONDS MIN. SWEEP TIME FROM OPEN
- I. FLUSH CONTROL SHALL BE ON WIDE SIDE OF TOILET COMPARTMENT AT ALL ACCESSIBLE STALLS - TYP J. WHERE ONLY ONE TYPE OF TOILET FIXTURE OR ACCESSORY IS USED, IT
- SHALL BE POSITIONED FOR ACCESSIBILITY K. SEE ACCESSIBILITY NOTES FOR ADDITIONAL REQUIREMENTS

PROJECT SITE: 111 S MAPLE AVE

ENTRANCES AND DOORWAYS

ENTRANCES AND DOORWAYS ,SHALL COMPLY WITH SECTION 11B-404

- A. PRIMARY ENTRANCES TO BUILDINGS AND FACILITIES SHALL BE MADE ACCESSIBLE TO THE DISABLED
- B. RECESSED DOOR MATS SHALL BE ANCHORED TO PREVENT INTERFERENCE WITH WHEELCHAIRS
- C. ACCESSIBLE ENTRANCES SHALL BE IDENTIFIED WITH AT LEAST ONE SIGN (INTERNATIONAL SYMBOL OF ACCESSIBILITY) AND WITH ADDITIONAL DIRECTIONAL SIGNS AS REQUIRED VISIBLE FROM APPROACHING PEDESTRIAN WAYS
- D. THE FLOOR OR LANDING ON EACH SIDE OF AN ENTRANCE OR PASSAGE DOOR SHALL BE LEVEL AND CLEAR. THE LEVEL AND CLEAR AREA SHALL BE A MINIMUM 60" SQUARE IN THE DIRECTION OF THE DOOR SWING AND A MINIMUM 44" SQUARE OPPOSITE THE DIRECTION OF DOOR SWING, THE SQUARES SHALL BE MEASURED AT RIGHT ANGLES TO THE PLANE OF THE DOOR IN ITS CLOSED POSITION.
- E. THE FLOOR OR LANDING SHALL BE NOT MORE THAN 1/2" LOWER THAN THE THRESHOLD OF THE DOORWAY. CHANGE IN LEVEL BETWEEN 1/4" AND 1/2" SHALL BE BEVELED NO GREATER THAN 1:2
- F. THE FLOOR LANDING IMMEDIATELY OUTSIDE THE ENTRY MAY BE SLOPED UP TO 1/8" PER FOOT IN THE DIRECTION AWAY FROM THE PRIMARY ENTRANCE FOR DRAINAGE
- G. EXTERIOR DECK, PATIO, OR BALCONY SURFACES SHALL BE NO MORE THAN 1/2" BELOW THE FLOOR LEVEL OF THE INTERIOR OF THE DWELLING UNIT, UNLESS CONSTRUCTED OF IMPERVIOUS MATERIALS. IN SUCH CASE THE SURFACE SHALL BE NO MORE THAN 4 INCHES BELOW THE FLOOR LEVEL OF THE INTERIOR OF THE DWELLING UNIT, OR LOWER IF REQUIRED BY LOCAL BUILDING CODES
- H. THE SPACE BETWEEN TWO CONSECUTIVE DOOR OPENINGS IN A VESTIBULE, SERVING OTHER THAN A REQUIRED EXIT STAIRWAY, MUST HAVE AT LEAST 48" OF CLEAR SPACE FROM ANY DOOR OPENING INTO THE VESTIBULE WHEN THE DOOR IS OPEN 90 DEGREES FROM ITS CLOSED POSITION. DOORS IN SERIES MUST SWING IN THE SAME DIRECTION OR AWAY FROM THE SPACE BETWEEN THE DOORS
- DOOR MUST PROVIDE MIN. 32" CLEAR OPENING WIDTH MEASURED WITH THE DOOR POSITIONED 90-DEGREES FROM THE CLOSED POSITION. DOOR MUST BE MIN. 36" IN WIDTH. WHERE A PAIR OF DOORS, MANUALLY OR AUTOMATICALLY OPERATED, IS UTILIZED, AT LEAST ONE OF THE DOORS SHALL PROVIDE A CLEAR, UNOBSTRUCTED OPENING 32" WIDE W/ THE LEAF POSITIONED 90 DEGREES FROM ITS CLOSED POSITION. DOORS SHALL NOT BE LESS THAN 6'-8" IN HEIGHT.
- J. THE BOTTOM 10" OF ALL DOORS EXCEPT AUTOMATIC & SLIDING SHALL HAVE A SMOOTH UNINTERRUPTED SURFACE TO ALLOW THE DOOR TO OPEN BY A WHEELCHAIR FOOTREST WITHOUT CREATING A TRAP OR HAZARDOUS CONDITION. WHERE NARROW FRAME DOORS ARE USED A 10" HIGH SMOOTH PANEL SHALL BE INSTALLED ON THE PUSH SIDE OF THE DOOR, WHICH WILL ALLOW THE DOOR TO BE OPENED BY A WHEELCHAIR FOOTREST WITHOUT CREATING A TRAP OR HAZARDOUS CONDITION. SEE CBC 11B-404.2.10
- K. MAXIMUM EFFORT TO OPERATE DOORS SHALL NOT EXCEED 5 LBS FOR EXTERIOR DOORS AND 5 LBS FOR INTERIOR DOORS, SUCH PULL OR PUSH EFFORT SHALL BE APPLIED AT RIGHT ANGLES TO HINGED DOORS AND AT THE CENTER PLANE OF SLIDING OR FOLDING DOORS. COMPENSATING DEVICES OR AUTOMATIC DOOR OPERATORS MAY BE UTILIZED TO MEET THE ABOVE STANDARDS. WHEN FIRE DOORS ARE REQUIRED, THE MAXIMUM EFFORT TO OPERATE THE DOOR MAY BE INCREASED TO THE MAXIMUM ALLOWABLE BY THE APPROPRIATE ADMINISTRATIVE AUTHORITY, NOT TO EXCEED 15 POUNDS
- THE SWEEP PERIOD OF A CLOSER SHALL BE ADJUSTED SO THAT FROM AN OPEN POSITION OF 90 DEGREES, THE DOOR WILL TAKE AT LEAST 5 SECONDS TO MOVE THE DOOR TO A POSITION OF 12 DEGREE FROM THE LATCH. DOOR AND GATE SPRING HINGES SHALL BE ADJUSTED SO THAT FROM THE OPEN POSITION OF 70 DEGREE THE DOOR OR GATE SHALL MOVE TO CLOSE POSITION IN 1.5 SECONDS MIN.
- M. OPERABLE HARDWARE SHALL COMPLY WITH CBC SECTION 11B-309.4. OPERABLE PART OF SUCH HARDWARE SHALL BE 34" MIN. AND 44" MAX. ABOVE THE FINISH FLOOR. HARDWARE SHALL BE OF A TYPE TO PERMIT OPERATION WITHOUT REQUIRING THE ABILITY TO GRASP THE HARDWARE.

ELECTRICAL NOTES PROJECT DATA

ELECTRICAL RECEPTACLE, SWITCH AND CONTROL HEIGHTS SHALL COMPLY WITH CBC SECTION 11B-308

DRAWING SYMBOLS

GENERAL NOTES

2. CONTRACTOR SHALL VERIFY ALL DIMENSIONS AND REPORT ANY ERROR

3. THE CONTRACTOR SHALL FIELD INSPECT THE PROJECT AND VERIFY ALL

4. THE CONTRACTOR SHALL LEAVE THE JOB BROOM CLEAN AT THE END OF

5. THE CONTRACTOR SHALL LEAVE THE JOB BROOM CLEAN, WINDOWS AND

FIXTURES WASHED AND DEBRIS MOVED FROM THE JOB SITE AT THE

MANUFACTURE'S SPECIFICATIONS AND RECOMMENDATIONS UNLESS

7. PRIOR TO FINAL ACCEPTANCE, ALL SYSTEMS, EQUIPMENT APPARATUS,

AND APPLIANCES SHALL OPERATE SAFELY AND SATISFACTORILY AS THE

8. CONTRACTOR TO PROVIDE OWNER WITH A HARD COVERING (3-RING,

ON ALL MECHANICAL ELEMENTS OF THE HOUSE (E.G. WATER HEATERS, KITCHEN APPLIANCES, HEATING UNITS, THERMOSTATS, ETC.). THE MANUAL

APPROVAL BY THE OWNER AND THE ARCHITECT FOR DOORS, WINDOWS,

10. CUT SHEETS OR SAMPLES SHALL BE PROVIDED FOR REVIEW AND FINAL APPROVAL BY THE OWNER AND THE ARCHITECT FOR ALL EQUIPMENT,

11. ALL VISIBLE WOOD WORK, INTERIOR + EXTERIOR, (INCLUDING BUT NOT

CASEWORK, CABINETS, ETC.) SHALL HAVE CLEAN, SQUARE CORNERS: NO

LIMITED TO FASCIA BOARDS, RAFTER TAILS, BRACKETS, WINDOWS, DOORS,

9. SHOP DRAWINGS SHALL BE PROVIDED FOR REVIEW AND FINAL

LIGHTING FIXTURES, PLUMBING FIXTURES, HARDWARE, AND FINISH

ROUNDED, RADIUS, OR EASED CORNERS SHALL BE VISIBLE UNLESS

ETC.) BINDER OWNER'S MANUAL FOR THE HOUSE. THE MANUAL SHOULD

INCLUDE MANUFACTURER'S INFORMATION, WARRANTIES, DIRECTIONS, ETC.

6. ALL MANUFACTURED ITEMS SHALL BE INSTALLED AS PER

SHOULD USE DIVIDERS FOR EASE OF REFERENCE.

AND CABINETS THROUGHOUT THE HOUSE.

MATERIALS THROUGHOUT THE PROJECT.

EXISTING CONDITIONS PRIOR TO COMMENCING WITH THE WORK.

OR OMISSION TO THE ARCHITECT PRIOR TO COMMENCING WITH THE WORK.

1. ALL WORK TO BE IN CONFORMANCE WITH ALL GOVERNING CODES,

SECTION TAG

(DRAWING NO.)

(SHEET NO.)

(DRAWING NO.)

(SHEET NO.)

DOOR NUMBER

WHETHER INDICATED ON THE DRAWINGS OR NOT.

\ (DRAWING NO.)

(A1.01) (SHEET NO.)

\A1.01∠

EACH DAYS WORK.

OTHERWISE NOTED.

DESIGN INTENDED.

OTHERWISE NOTED.

COMPLETION OF THE PROJECT.

DATUM POINT, DIMENSION POINT

EXTERIOR ELEVATION TAG

WINDOW NUMBER

- A. ELECTRICAL RECEPTACLE OUTLETS ON BRANCH CIRCUITS OF 30 AMPERES OR LESS AND COMMUNICATION SYSTEM RECEPTACLES SHALL BE LOCATED NO MORE THAN 48" MEASURED FROM THE TOP OF THE RECEPTACLE OUTLET BOX OR RECEPTACLE HOUSING NOR LESS THAN 15" MEASURED FROM THE BOTTOM OF THE RECEPTACLE OUTLET BOX OR RECEPTACLE HOUSING TO THE LEVEL OF THE FINISHED FLOOR OR WORKING PLATFORM. IF THE REACH IS OVER AN OBSTRUCTION BETWEEN 20" AND 25" IN DEPTH, THE MAXIMUM HEIGHT MEASURED AT THE BOX IS REDUCED TO 44" FOR FORWARD APPROACH, OR 46" FOR SIDE APPROACH, PROVIDED THE OBSTRUCTION IS NO MORE THAN 24" IN DEPTH. OBSTRUCTIONS SHALL NOT EXTEND MORE THAN 25" FROM THE WALL BENEATH THE RECEPTACLE. OUTLETS THAT DO NOT SATISFY THESE SPECIFICATIONS ARE ACCEPTABLE PROVIDED THAT COMPARABLE OUTLETS, THAT PERFORM THE SAME FUNCTIONS, ARE PROVIDED WITHIN THE SAME AREA AND ARE ACCESSIBLE. EXCEPTIONS
 - INCLUDE THE FOLLOWING: 1. RECEPTACLE OUTLETS INSTALLED AS PART OF PERMANENTLY
- INSTALLED BASEBOARD HEATERS ARE EXEMPT 2. REQUIRED RECEPTACLE OUTLETS SHALL BE PERMITTED IN FLOORS WHEN ADJACENT TO SLIDING PANELS OR WALLS 3. BASEBOARD ELECTRICAL OUTLETS USED IN RELOCATABLE PARTITIONS, WINDOW WALLS OR OTHER ELECTRICAL
- MINIMUM HEIGHT REQUIREMENTS 4. THIS SECTION SHALL NOT APPLY TO EXISTING BUILDINGS WHEN THE ENFORCING AGENCY DETERMINES THAT COMPLIANCE WITH THESE STANDARDS WOULD CREATE AN UNREASONABLE HARDSHIP NOTE: THE INTENT OF THE MEASUREMENT IS TO ENSURE THAT RECEPTACLES FALL WITHIN THE REACH RANGE OF 15" TO 48"
- B. CONTROLS OR SWITCHES INTENDED TO BE USED BY THE OCCUPANT OF THE ROOM OR AREA TO CONTROL LIGHTING AND RECEPTACLE OUTLETS, APPLIANCES, ALARMS OR COOLING, HEATING AND VENTILATING EQUIPMENT SHALL BE LOCATED NO MORE THAN 48" MEASURED FROM THE TOP OF THE OUTLET BOX NOR LESS THAN 15" MEASURED FROM THE BOTTOM OF THE OUTLET BOX TO THE LEVEL OF THE FINISHED FLOOR OR WORKING PLATFORM. IF THE REACH IS OVER A PHYSICAL BARRIER OR AN OBSTRUCTION (FOR EXAMPLE, A KITCHEN BASE CABINET) BETWEEN 20" AND 25" IN DEPTH, THE MAXIMUM HEIGHT IS REDUCED TO 44" FOR FORWARD APPROACH, OR 46" FOR SIDE APPROACH, PROVIDED THE OBSTRUCTION IS NO MORE THAN 24" IN DEPTH. PHYSICAL BARRIERS OR OBSTRUCTIONS SHALL NOT EXTEND MORE THAN 25" FROM THE WALL BENEATH THE CONTROL. CONTROLS THAT DO NOT SATISFY THESE SPECIFICATIONS ARE ACCEPTABLE PROVIDED THAT COMPARABLE CONTROLS OR OUTLETS, THAT PERFORM THE SAME FUNCTIONS, ARE PROVIDED WITHIN THE SAME AREA AND ARE ACCESSIBLE
- C. THE CENTER OF THE GRIP OF THE OPERATING HANDLE OF SWITCHES INTENDED TO BE USED BY THE OCCUPANT OF THE ROOM OR AREA TO CONTROL LIGHTING AND RECEPTACLE OUTLETS, APPLIANCES, OR COOLING, HEATING AND VENTILATING EQUIPMENT, SHALL BE NOT LESS THAN 3 FEET NOR MORE THAN 4 FEET ABOVE THE FLOOR OR WORKING PLATFORM
- D. THE CENTER OF FIRE ALARM INITIATING DEVICES (BOXES) SHALL BE LOCATED 48" ABOVE THE LEVEL OF THE FLOOR, WORKING PLATFORM, GROUND SURFACE OR SIDEWALK. IF EMERGENCY WARNING SYSTEMS ARE REQUIRED THEY SHALL ACTIVATE A MEANS OF WARNING THE HEARING IMPAIRED

PROJECT DIRECTORY

CREF3 MAPLE OWNER LLC

LOS ANGELES, CA 90049

C&J CONTRACTING, INC.

EMAIL: cjreno@cnjcontr.com

CONTACT: ALEX CHEN

987 CORPORATE WAY,

FREMONT, CA 94539

T. 510.613.3223

YAO CHEN ARCHITECTURE STUDIO

EMAIL: YCHEN@YCARCHSTUDIO.COM

CONTACT: CHRIS RENO

331 COMMERCIAL ST.,

SAN JOSE, CA 95112

T 831 566 4948

T. 646.951.7219

CONTACT: BRADY THOMSON

EMAIL: bthomson@fortress.com

11611 SAN VICENTE BLVD. 10TH FLR.

OWNER

GENERAL

CONTRACTOR

ARCHITECT

PARCEL: 014-092-120 T5 LINDENVILLE ZONING: B, S-1, S-2, F-2, M OCCUPANCY GROUP: (NON-SEPARATED PER CBC 508.3) CONSTRUCTION TYPE:

YES FIRE SPRINKLER: NO. OF STORY:

BUILDING FOOTPRINT: 27,268 SF (UNCHANGE) OFFICE AREA: 4,280 SF (16% < 30% MAX) WAREHOUSE AREA

LOT AREA: 54,600 SF LOT COVERAGE: 50%

PARKING REQUIREMENT (CLEAN TECH): OFFICE AREA: WAREHOUSE AREA: CONVENIENCE FLOOR OUTLETS ARE NOT SUBJECT TO THE

YEAR BUILT:

15 (1/300 SF) 15 (1/2000 SF) 30 TOTAL REQUIRED. 34 PROVIDED ON SITE.

APPLICABLE CODES

DRAWING INDEX

OVERALL PROPOSED FLOOR PLAN

PROPOSED RCP - OFFICE AREA

FIRE AND LIFE SAFETY PLAN

OVERALL PROPOSED POWER LOCATION PLAN

EXISTING/ DEMO FLOOR PLAN - OFFICE AREA

PROPOSED FINISH FLOOR PLAN - OFFICE AREA

PROPOSED FLOOR PLAN - OFFICE AREA

PROJECT INFO

SITE PLAN

ARCHITECTURE

A-001

A-201

A-202

A-210

A-211

A-212

A-213

A-214

2022 CALIFORNIA BUILDING CODE 2022 CALIFORNIA ELECTRICAL CODE 2022 CALIFORNIA PLUMBING CODE 2022 CALIFORNIA MECHANICAL CODE 2022 CALIFORNIA ENERGY CODE 2022 CALIFORNIA GREEN BUILDING STANDARDS CODE 2022 CALIFORNIA FIRE CODE

2022 EDITION OF THE TITLE 24 STANDARDS

CITY CODES AND ORDINANCES

PROJECT SCOPE OF WORK

- TENANT IMPROVEMENT WITH LIMITED SCOPE TO: 1. MERGE STORAGE ROOM 111 WITH CONFERENCE ROOM 110. 2. MERGE OFFICE 121 AND 122 TO TURN INTO CONFERENCE ROOM 120.
- 3. RELOCATE DOORS AT THE CONFERENCE ROOM 110 AND 120. 4. REMOVE NON-LOAD BEARING WALL AT KITCHEN
- 5. INSTALL ELECTRICAL OUTLETS AT THE OFFICE AREA. 6. INSTALL EQUIPMENT AT THE OPEN WAREHOUSE AREA. 7. INSTALL OUTLET FOR POWER SUPPLY TO EQUIPMENT.
- 8. INSTALL EXHAUST FAN FOR EQUIPMENT REFER TO MECH PLAN.

SITE - INSTALL NEW 6' HEIGHT FENCING ALONG THE SOUTH PROPERTY LINE.

SIGNAGE - GENERAL

SIGNS: WHEN SIGNS AND/ OR IDENTIFICATION DEVICES ARE PROVIDED THEY SHALL COMPLY WITH CBC SECTION 11B-216 AND SECTION 11B-703

- A. IDENTIFICATION SIGNS SHALL COMPLY WITH ALL REQUIREMENTS, DIRECTION AND INFORMATION SIGNS SHALL COMPLY WITH FINISH, PROPORTIONS, AND CHARACTER HEIGHT, ACCESSIBILITY SIGNS SHALL COMPLY WITH FINISH AND CONTRAST
- B. CONTRACTOR SHALL SUBMIT SHOP DRAWINGS AND SAMPLES OF ALL SIGNAGE FOR REVIEW BY THE OWNER, ARCHITECT

987 CORPORATE WAY FREMONT, CA 94539 510.613.3223 Email: ychen@ycarchstudio.com

©YCAS 2024

APPLICANT:

C&J CONTRACTING, INC

331 COMMERCIAL ST SAN JOSE, CA 95112

TENANT & SITE IMPROVEMENT


PARCEL NO: 42-4548-4

111 S. MAPLE AVE. SOUTH SAN FRANCISCO, CA 94080

DRAWING SUBMITTAL SCHEDULE 2024.05.23 PROGRESS SET

PROJECT NO: -


PROJECT INFO.

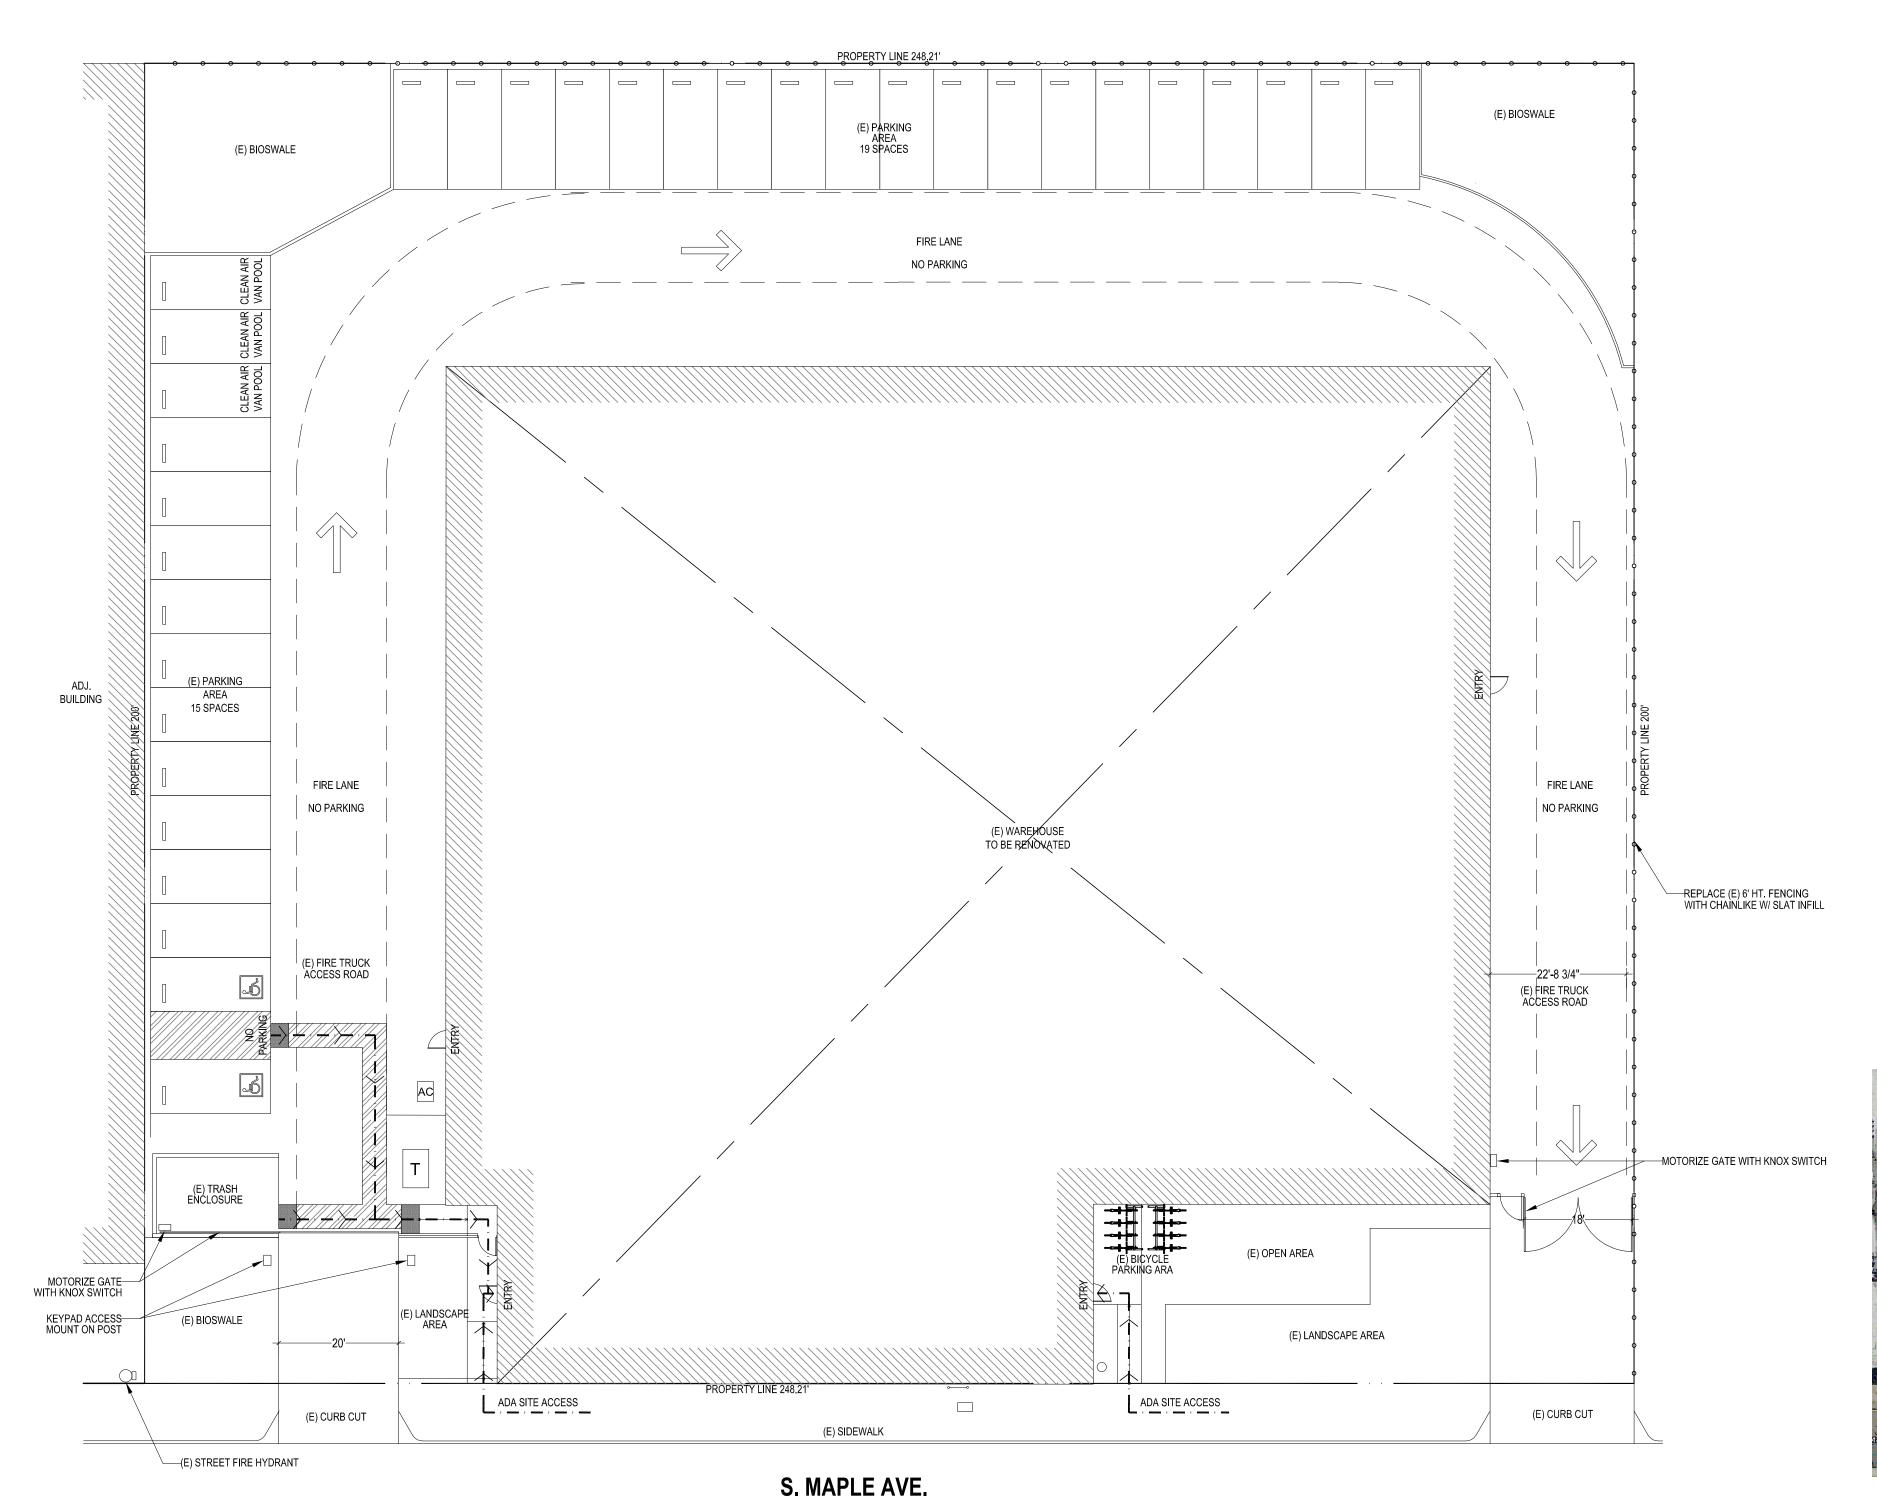

TOTAL NO. OF PARKING SPACES PROVIDED ON SITE: 34

TOTAL NO. OF REQUIRED SPACE FOR CLEAN TECH: 30
OFFICE AREA: 15 REQUIRED
WAREHOUSE AREA: 15 REQUIRED

LOT AREA: 54,600 SF BUILDING AREA: 27,268 SF LOT COVERAGE: 50%

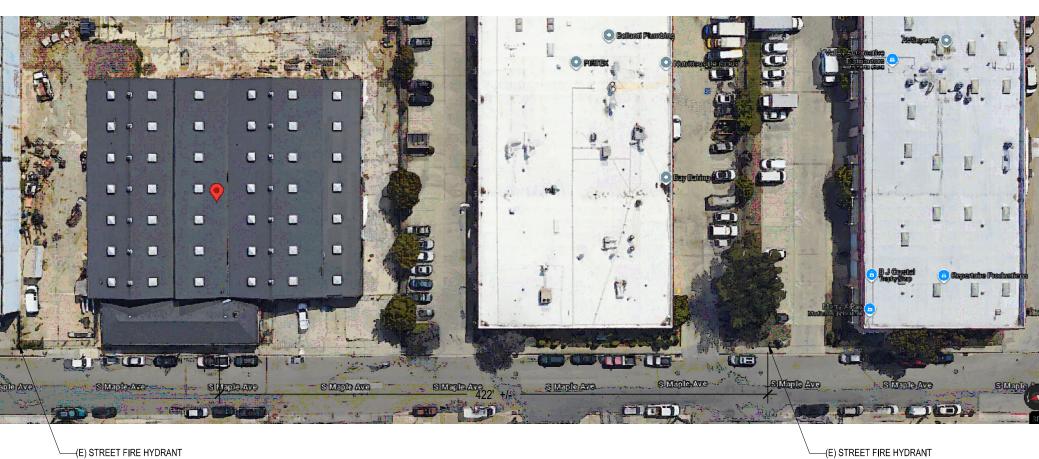

2 VICINITY MAP

NOT TO SCALE



Email: ychen@ycarchstudio.com

©YCAS 2024

APPLICANT:

C&J CONTRACTING, INC

331 COMMERCIAL ST. SAN JOSE, CA 95112

TENANT & SITE IMPROVEMENT

PARCEL NO: 42-4548-4

111 S. MAPLE AVE. SOUTH SAN FRANCISCO, CA 94080

DRAWING SUBMITTAL SCHEDULE

2024.06.14 MINOR USE PERMIT APPLICATION
2024.07.24 PLAN CHECK SUBMITTAL


PROJECT NO: -


SITE PLAN

A-101

SITE PLAN

SCALE: 1/16"=1'-0"

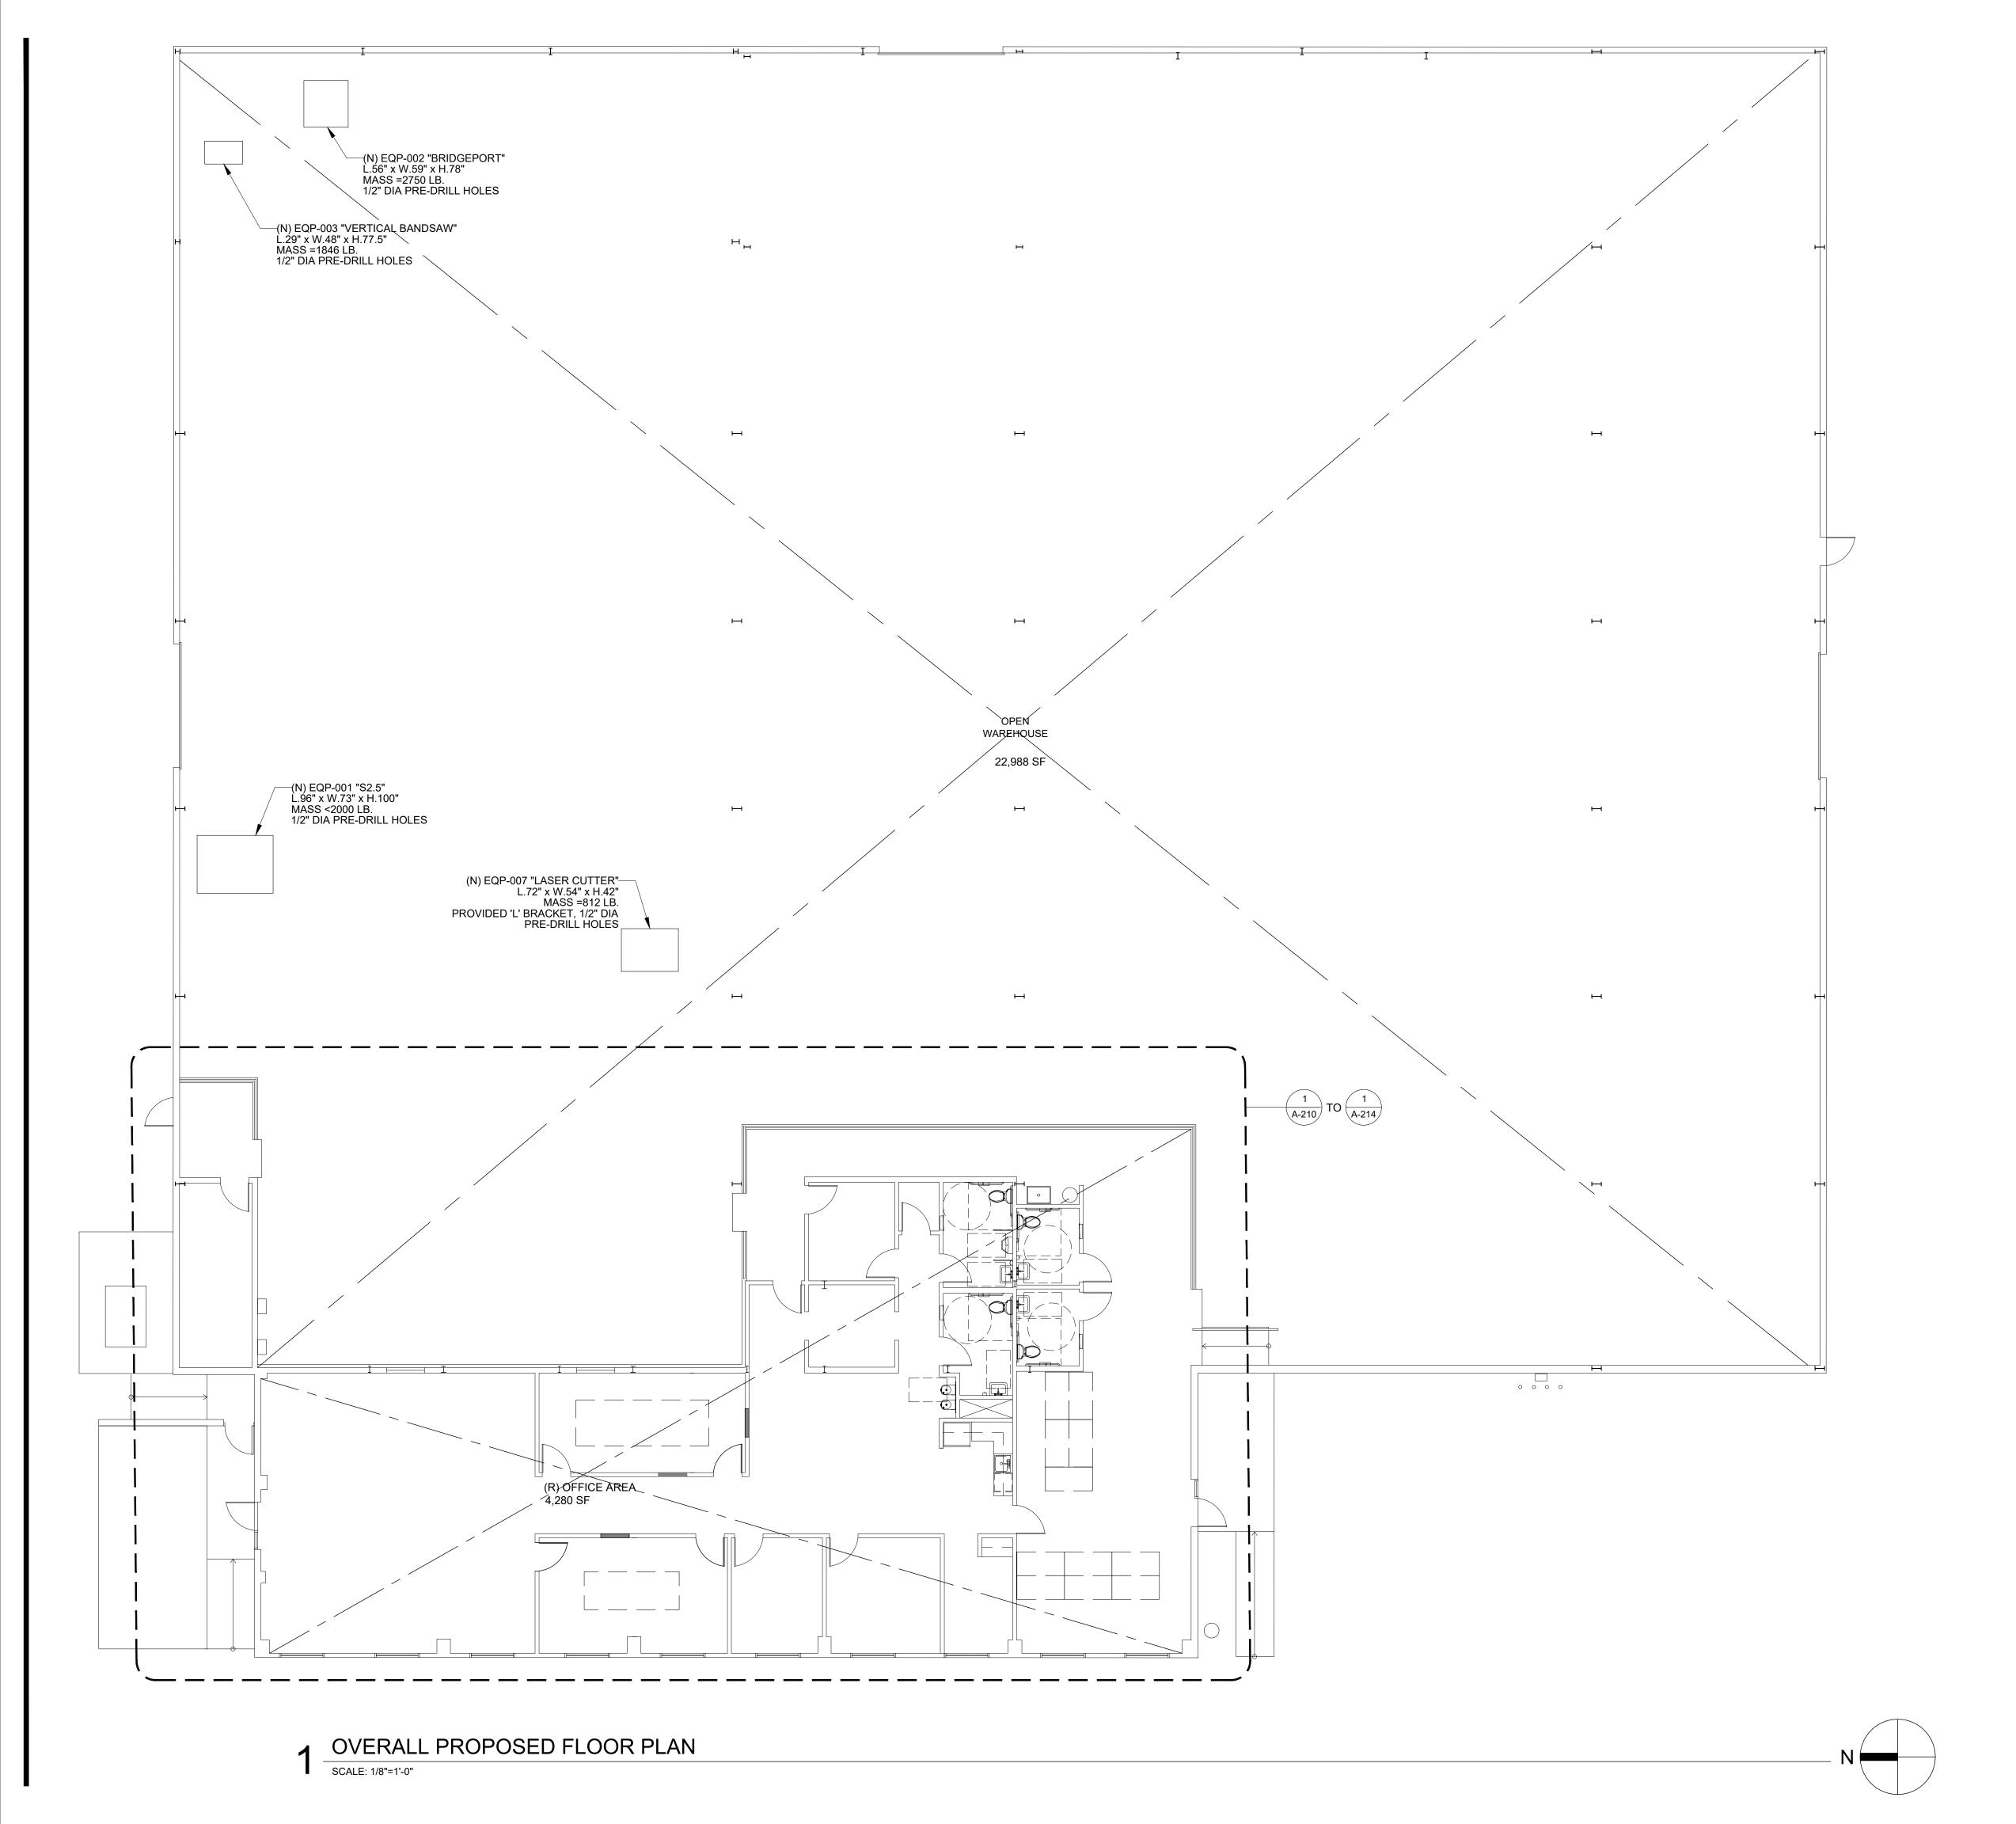

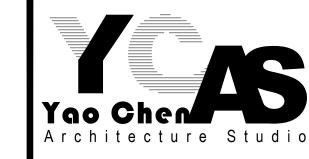

987 CORPORATE WAY, FREMONT, CA 94539 510.613.3223

Email: ychen@ycarchstudio.com

©YCAS 2024

APPLICANT:

C&J CONTRACTING, INC

331 COMMERCIAL ST. SAN JOSE, CA 95112

TENANT & SITE IMPROVEMENT


PARCEL NO: 42-4548-4

111 S. MAPLE AVE. SOUTH SAN FRANCISCO, CA 94080

DRAWING SUBMITTAL SCHEDULE
2024.06.14 MINOR USE PERMIT APPLICATION

PROJECT NO: -

OVERALL
PROPOSED FLOOR PLAN

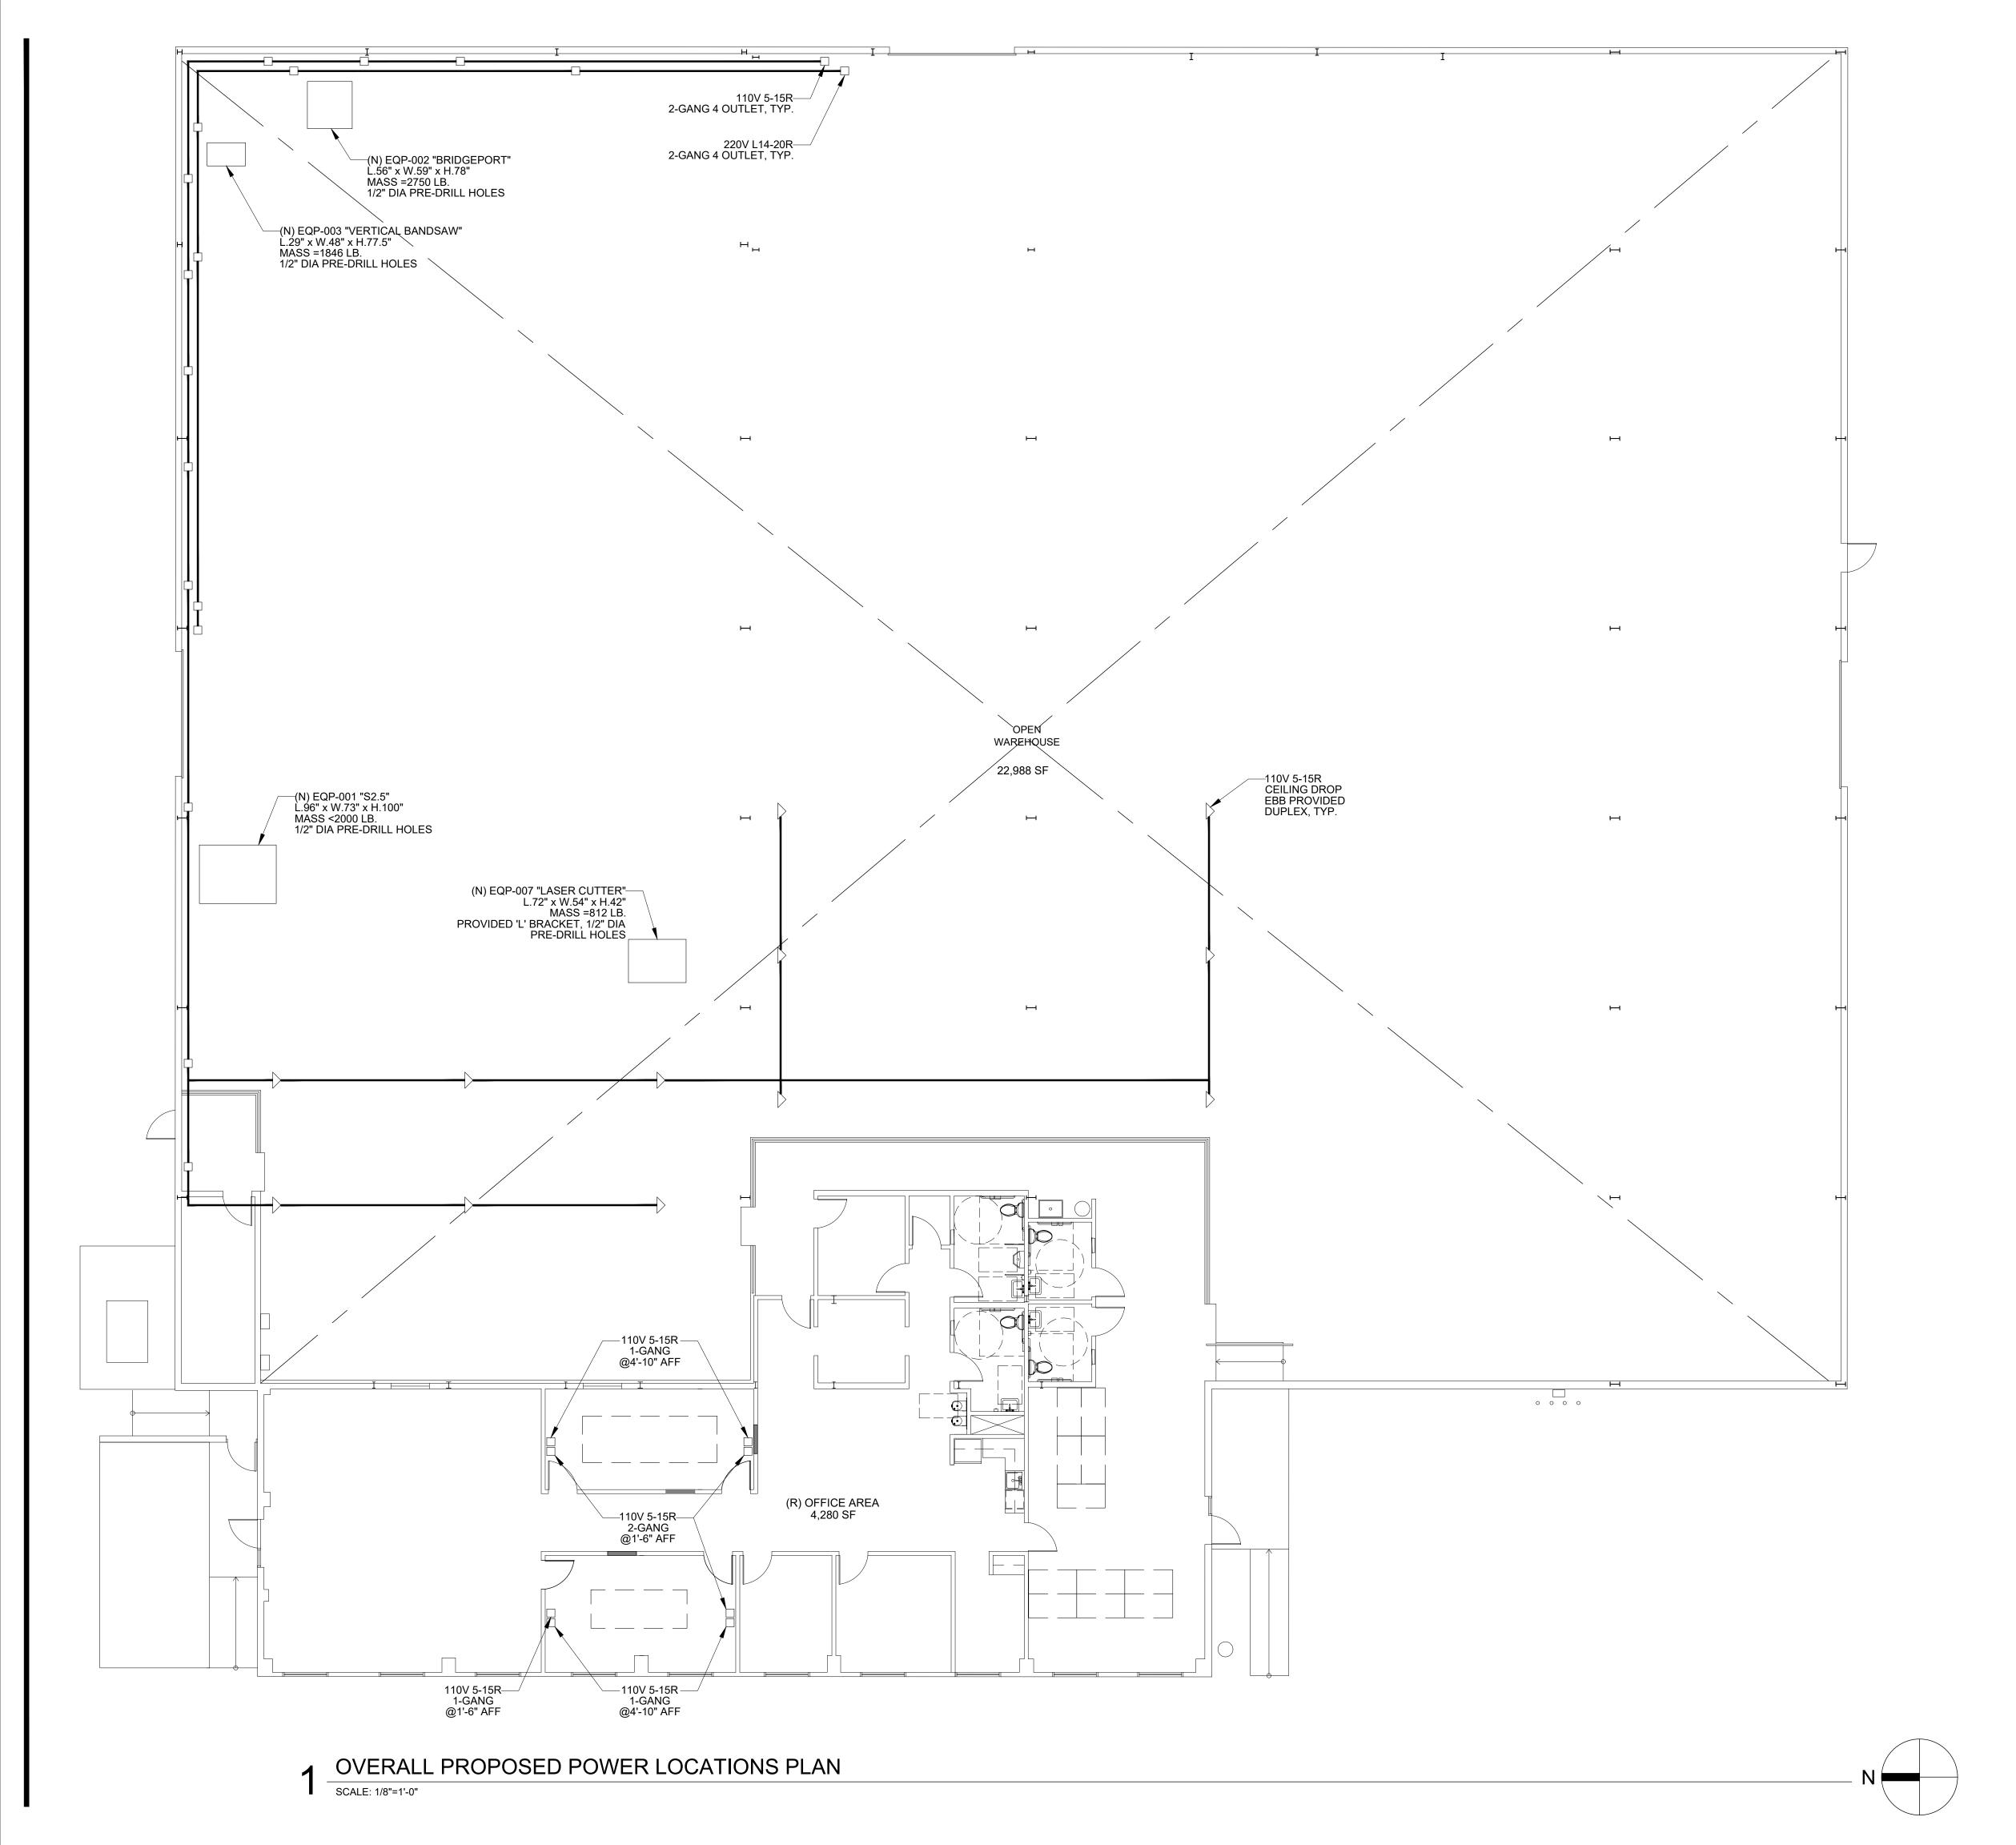

LEGEND:

WALL MOUNT OUTLET

CEILING DROP OUTLET

ELEC. CONDUIT



987 CORPORATE WAY, FREMONT, CA 94539 510.613.3223

Email: ychen@ycarchstudio.com

©YCAS 2024

APPLICANT:

C&J CONTRACTING, INC

331 COMMERCIAL ST. SAN JOSE, CA 95112

TENANT & SITE IMPROVEMENT

PARCEL NO: 42-4548-4

111 S. MAPLE AVE. SOUTH SAN FRANCISCO, CA 94080

DRAWING SUBMITTAL SCHEDULE

2024.06.14 MINOR USE PERMIT APPLICATION

PROJECT NO: -


OVERALL
PROPOSED POWER
LOCATIONS PLAN




(E) WALL TO REMAIN

(E) TO BE DEMOLISHED

(E) WALL TO BE DEMOLISHED

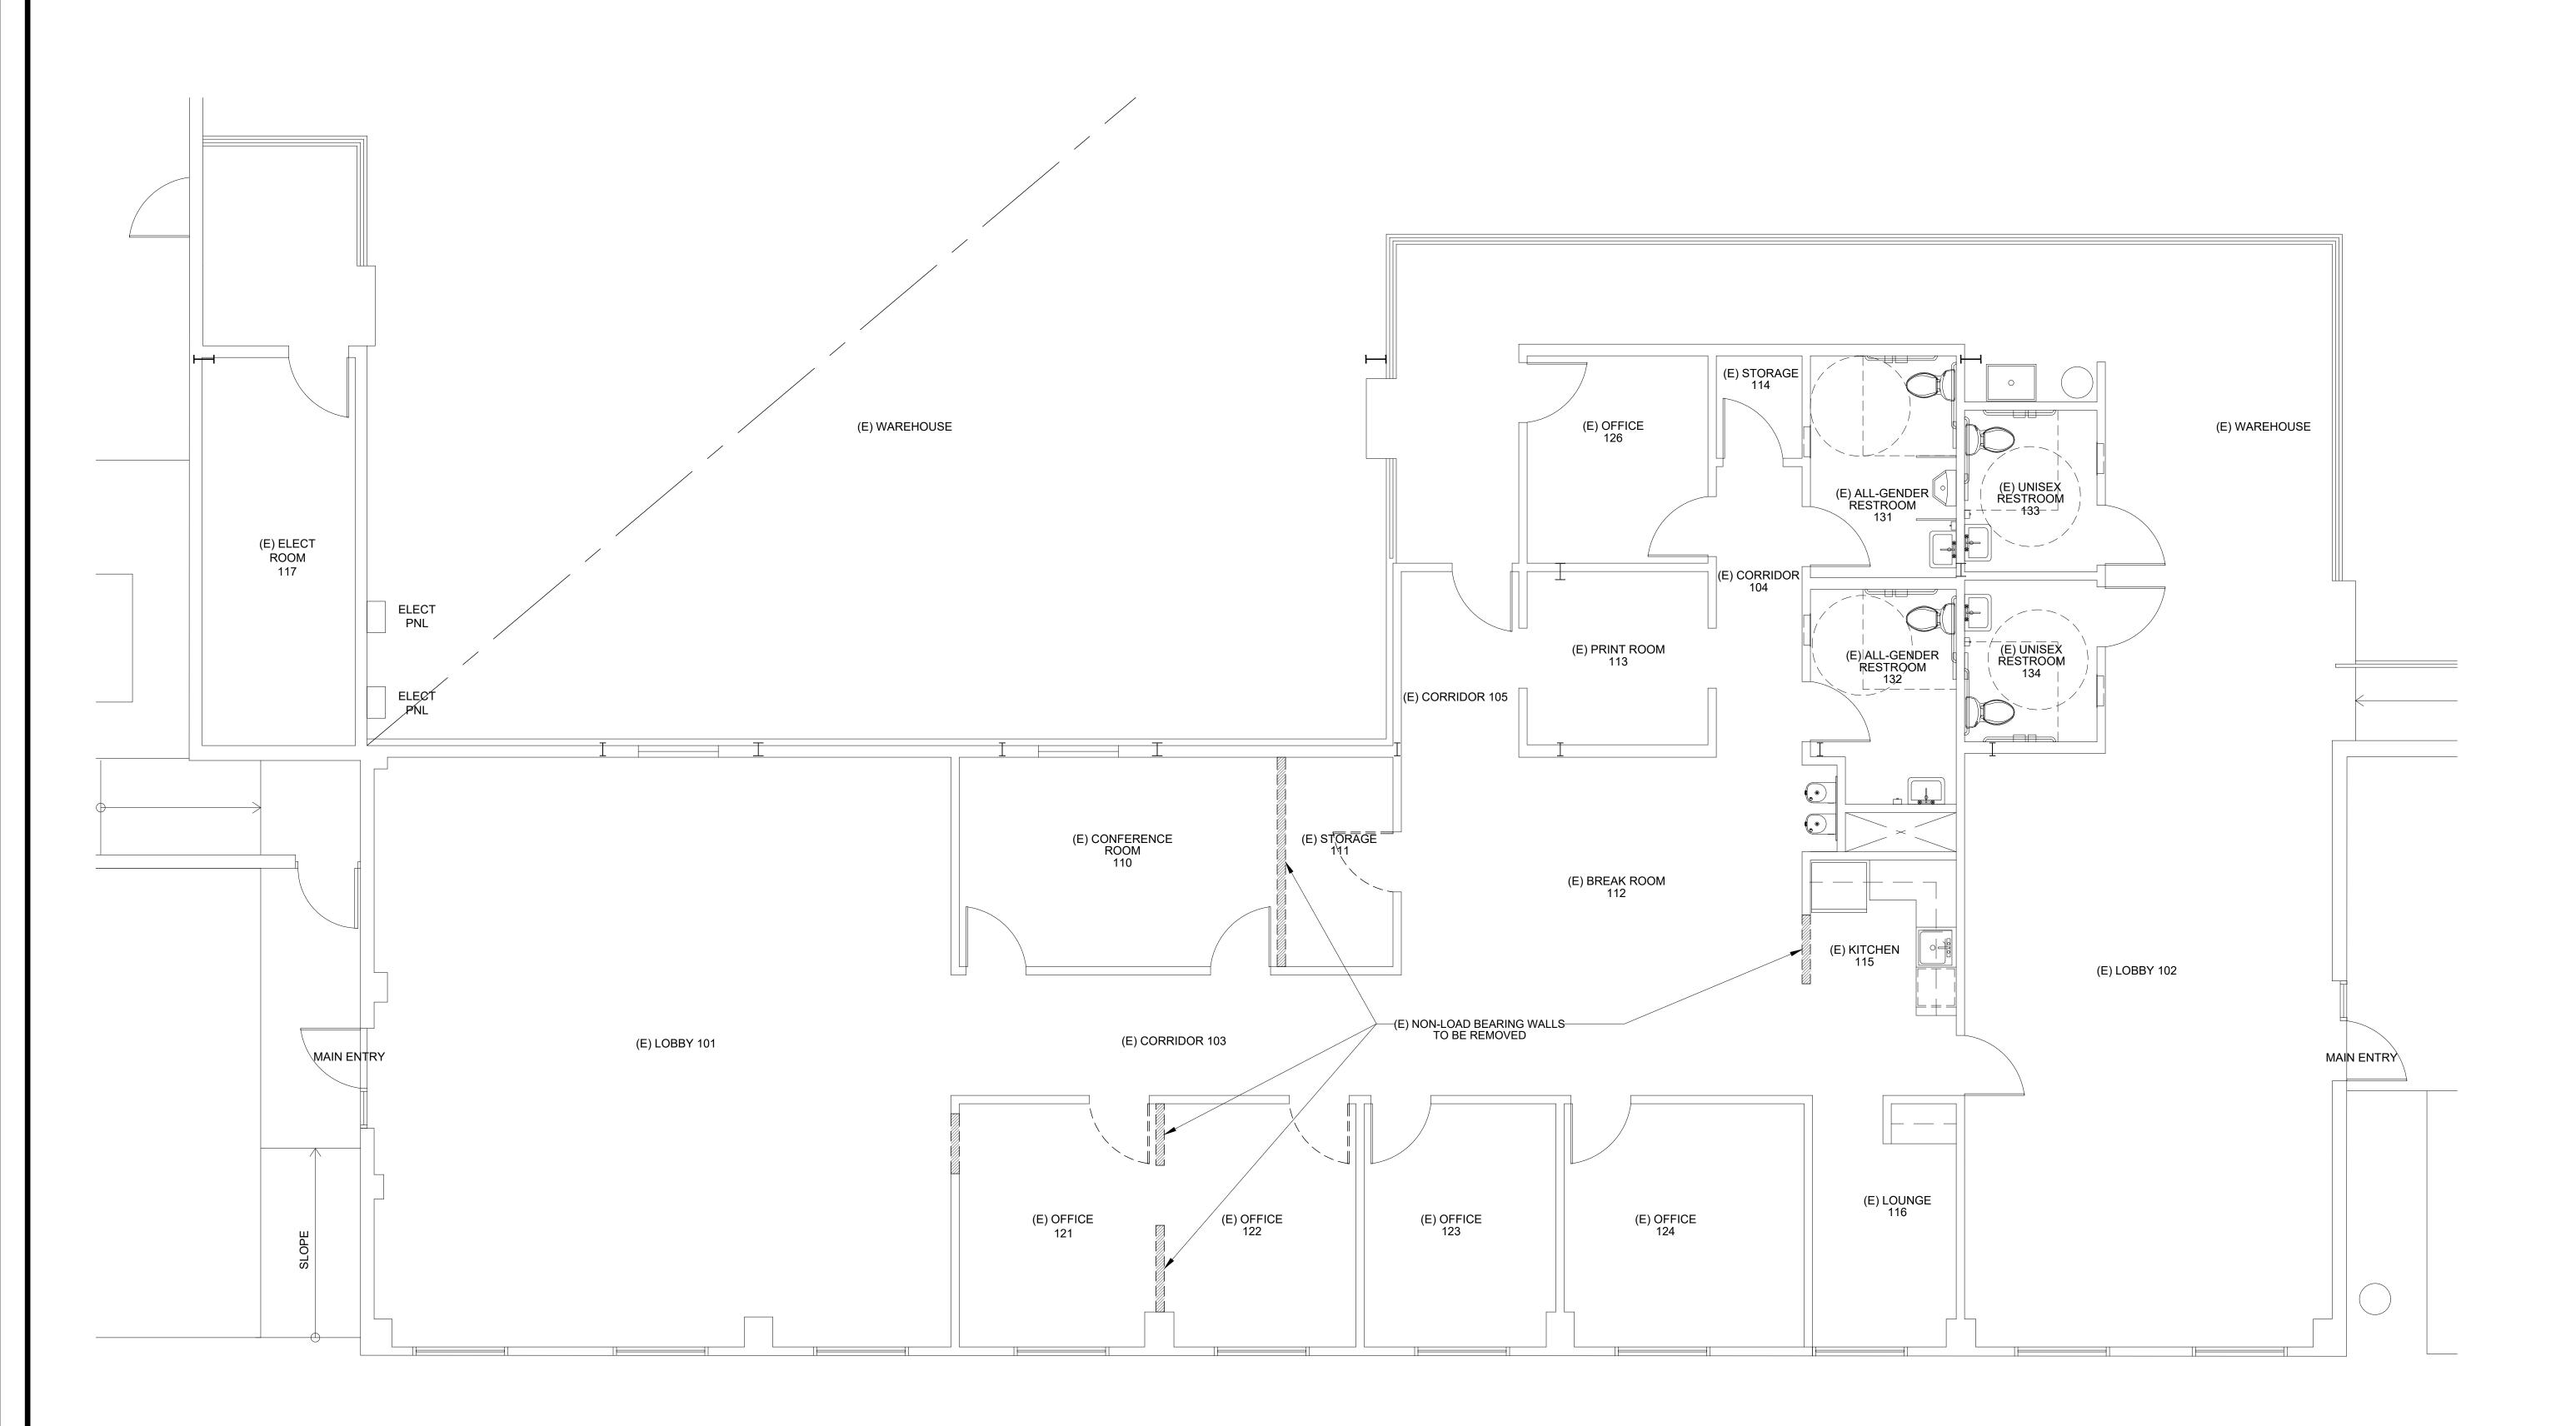

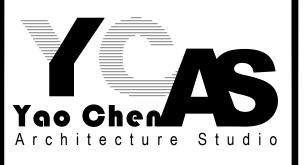

987 CORPORATE WAY, FREMONT, CA 94539 510.613.3223

Email: ychen@ycarchstudio.com

©YCAS 2024

APPLICANT:

C&J CONTRACTING, INC

331 COMMERCIAL ST. SAN JOSE, CA 95112

TENANT & SITE IMPROVEMENT

PARCEL NO: 42-4548-4

111 S. MAPLE AVE. SOUTH SAN FRANCISCO, CA 94080

DRAWING SUBMITTAL SCHEDULE

2024.06.14 MINOR USE PERMIT APPLICATION

PROJECT NO: -

EXISTING / DEMO FLOOR PLAN - OFFICE AREA

WALL LEGEND

(E) WALL TO REMAIN

(N) WALL

LEGEND

XX


DOOR TYPE


DOOR SCHEDULE

NAME	NEW	EXISTING	SIZE (W x H)	FIRE-RATING	DOOR TYPE	FRAME	DOOR	REMARK
NG-1	Х		3'-0" X 7'-0"	-	D	ALUM	ALUM/ GL	DOOR STOP, CYLINDRICAL LOCK
G-1		Х	3'-0" X 7'-0"	-	D	ALUM	ALUM/ GL	DOOR STOP, CYLINDRICAL LOCK
S-1		Х	3'-0" X 7'-0"	-	С	ALUM	SCWD	DOOR STOP, CYLINDRICAL LOCK
S-2		Х	3'-0" X 7'-0"	-	С	ALUM	SCWD	DOOR STOP, CYLINDRICAL LOCK, DOOR SELF-CLOSER
E-1		Х	3'-0" X 7'-0"	-	A	ALUM	ALUM/ GL	CYLINDRICAL LOCK, PUSH BAR, DOOR SWEEP, WEATHERSTRIPPING, THRESHOLD, SELF-CLOSER
E-2		Х	3'-0" X 7'-0"		В	ALUM	SCWD/ GL	CYLINDRICAL LOCK, DOOR SWEEP, THRESHOLD, SELF-CLOSER,
E-3		Х	3'-0" X 7'-0"		В	ALUM	SCWD/ GL	CYLINDRICAL LOCK, PUSH BAR, DOOR SWEEP, THRESHOLD, SELF-CLOSER
E-4		Х	3'-0" X 7'-0"		Е	НМ	HM/ GL	CYLINDRICAL LOCK, PUSH BAR, DOOR SWEEP, THRESHOLD, SELF-CLOSER,

GL - GLASS SCWD - SOLID CORE WOOD DOOR HM - HOLLOW METAL ALUM - ALUMINUM STL - STEEL

TEMP. - TEMPERED GLASS

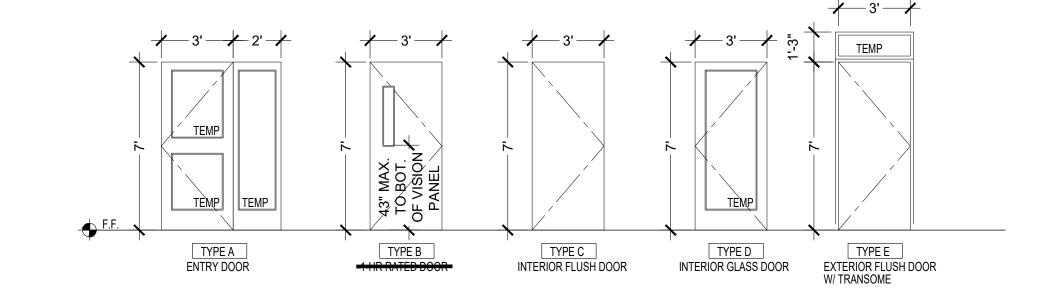

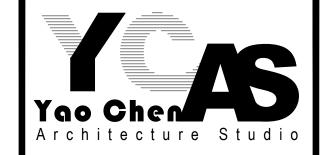

987 CORPORATE WAY, FREMONT, CA 94539 510.613.3223


Email: ychen@ycarchstudio.com

©YCAS 2024

APPLICANT:

C&J CONTRACTING, INC

331 COMMERCIAL ST. SAN JOSE, CA 95112

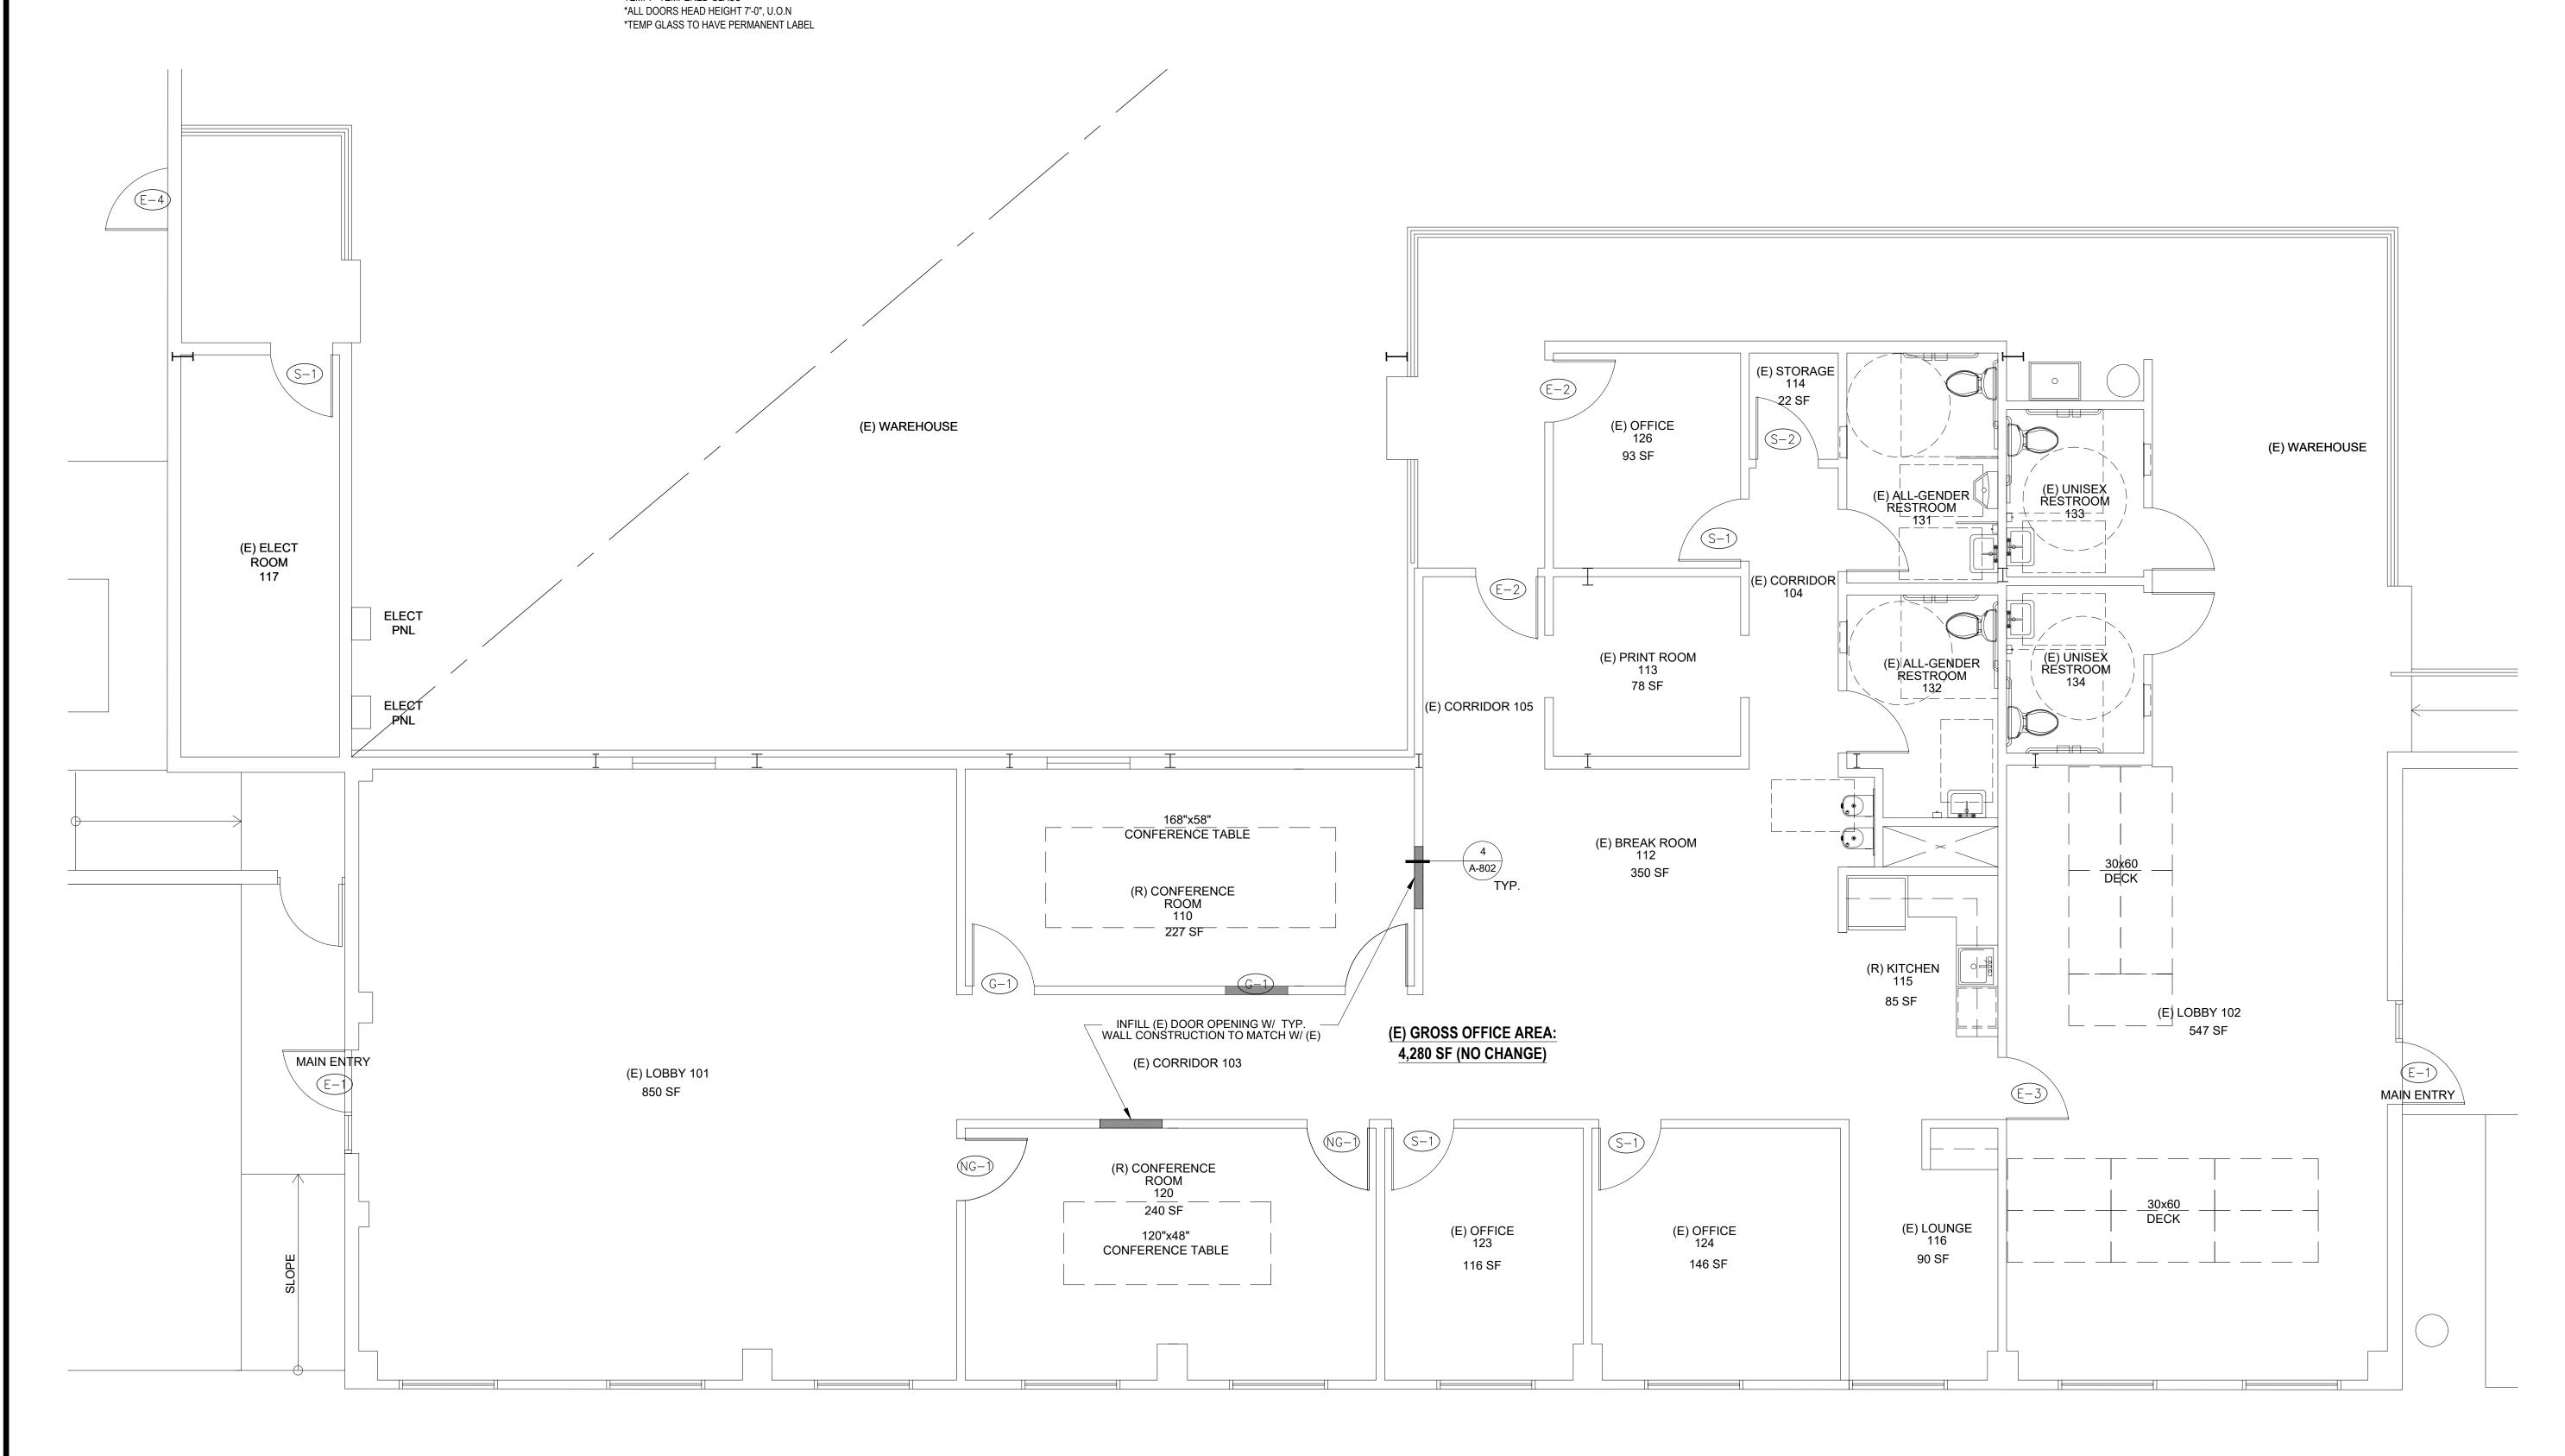

TENANT & SITE IMPROVEMENT


PARCEL NO: 42-4548-4


111 S. MAPLE AVE. SOUTH SAN FRANCISCO, CA 94080

DRAWING SUBMITTAL SCHEDULE 2024.06.14 MINOR USE PERMIT APPLICATION

PROJECT NO: -

PROPOSED FLOOR **PLAN - OFFICE AREA**

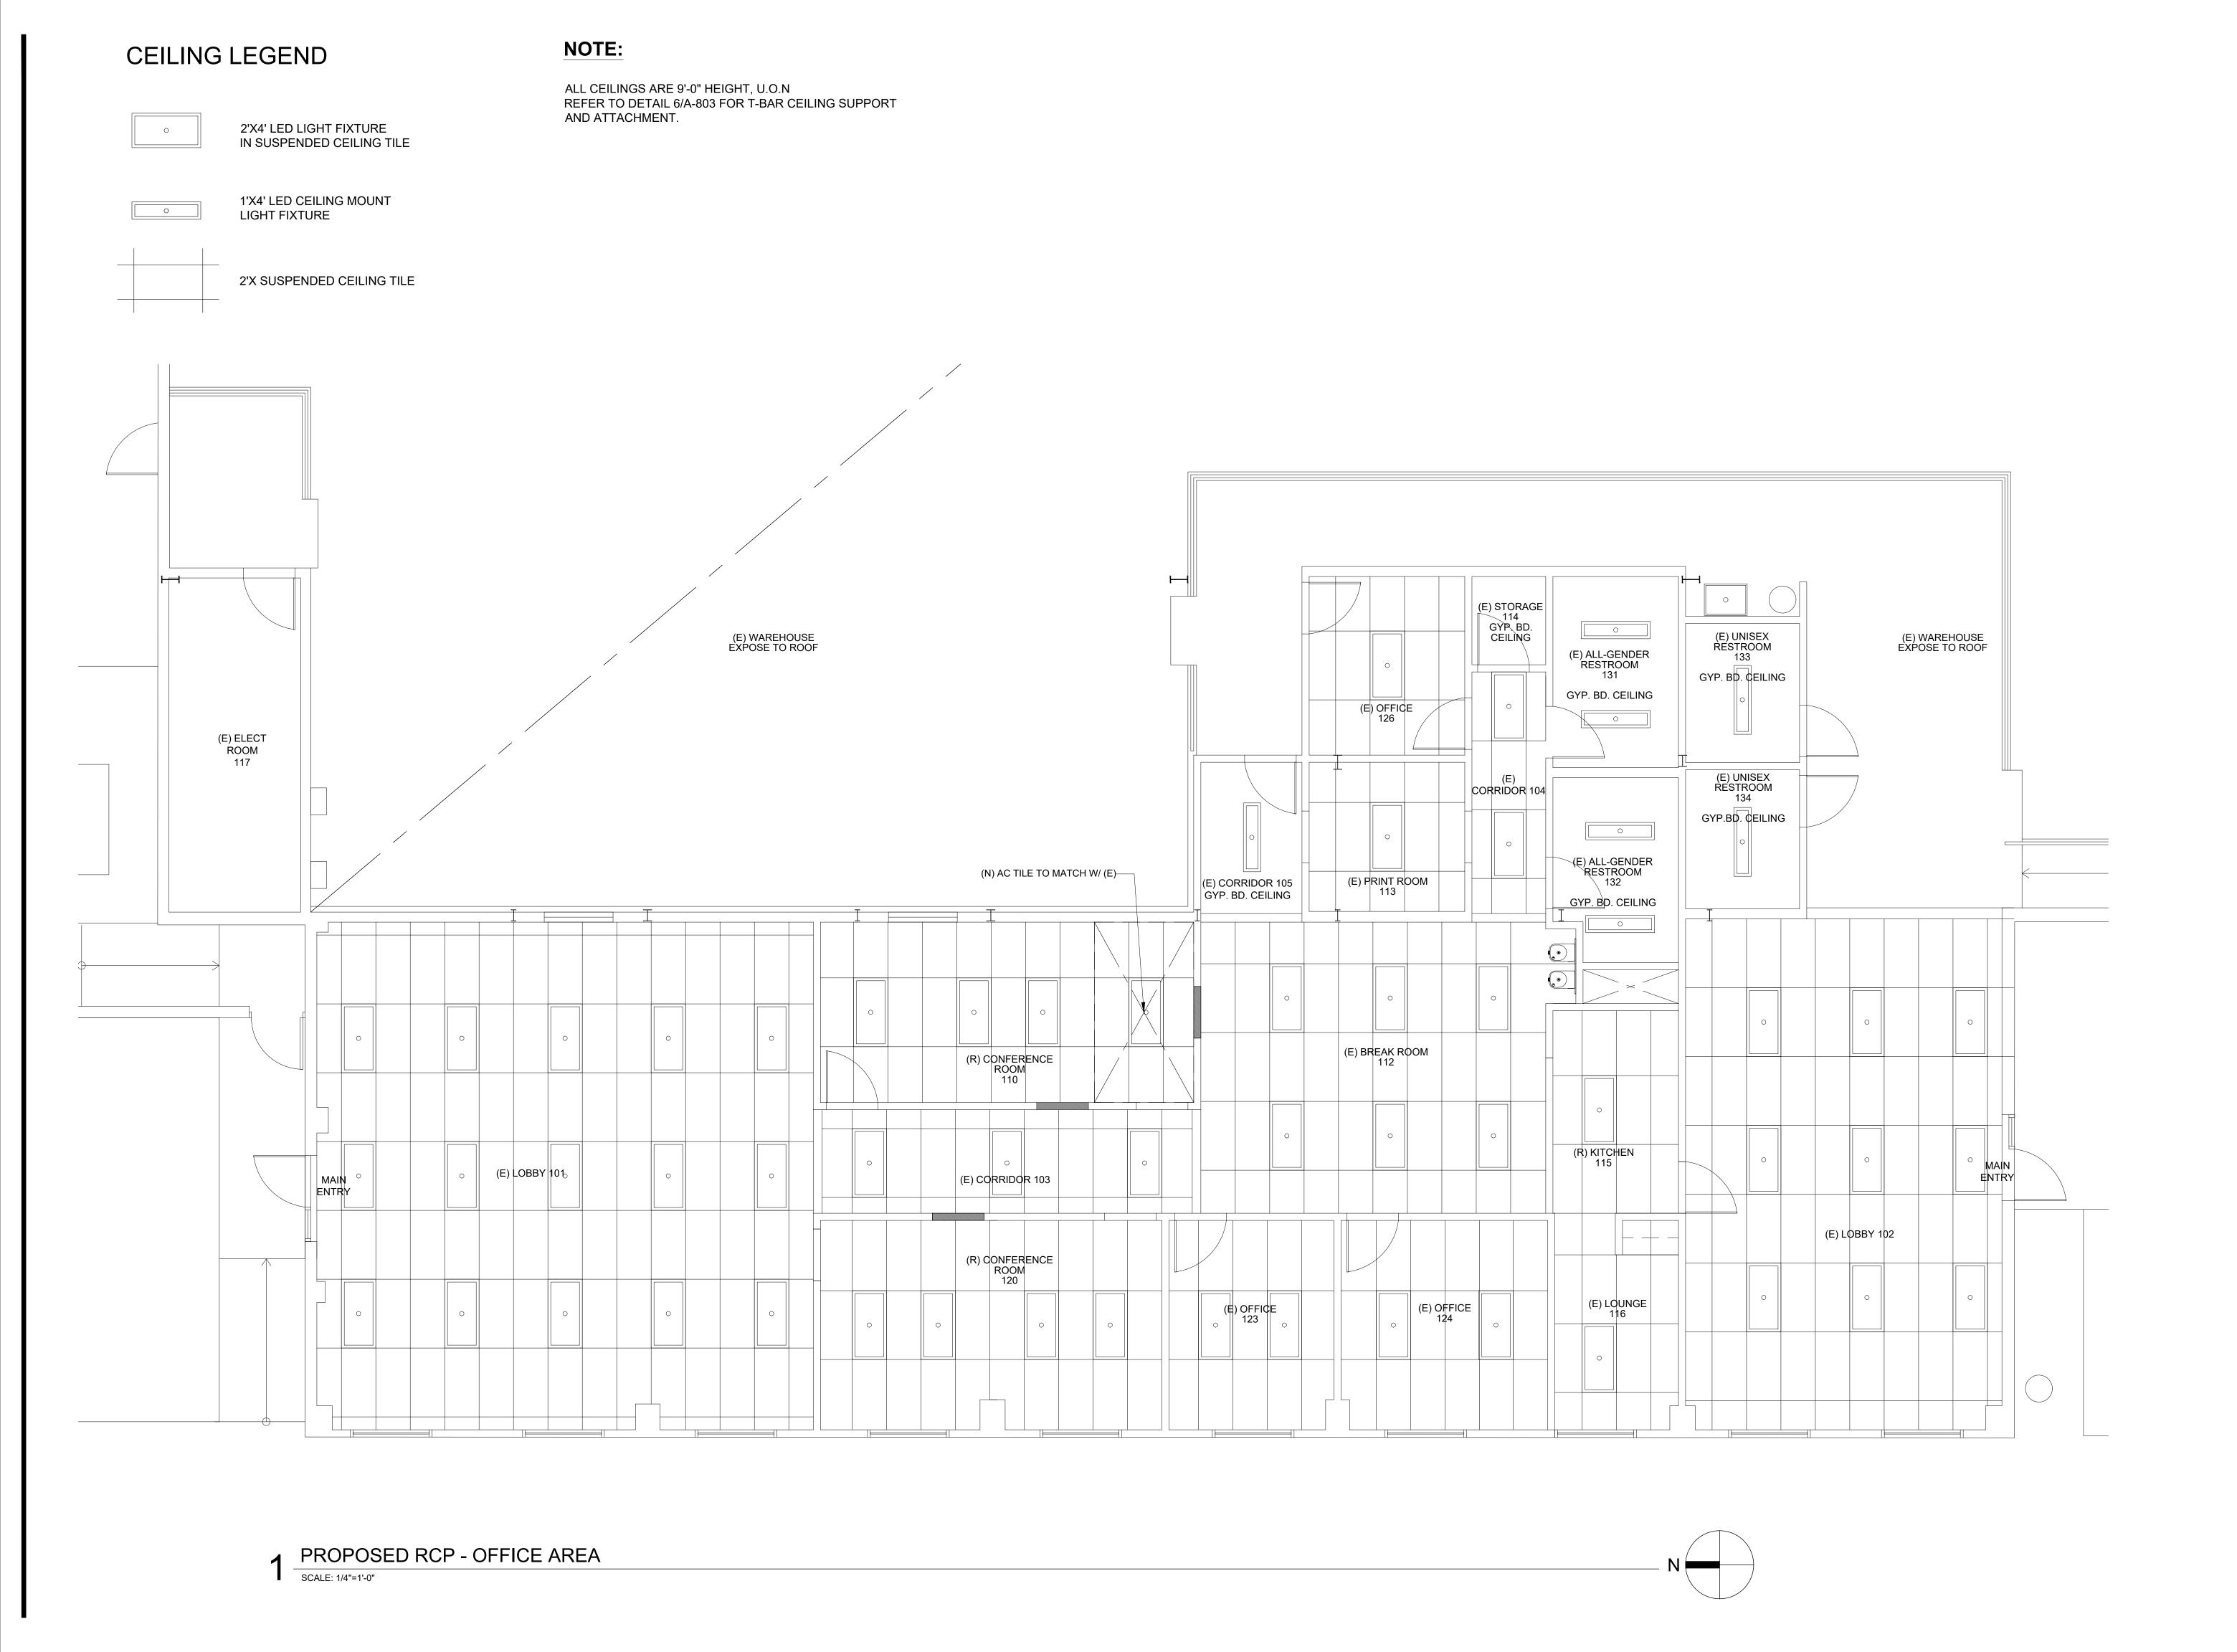

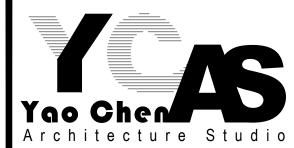

987 CORPORATE WAY, FREMONT, CA 94539 510.613.3223

Email: ychen@ycarchstudio.com

©YCAS 2024

APPLICANT:

C&J CONTRACTING, INC

331 COMMERCIAL ST. SAN JOSE, CA 95112

TENANT & SITE IMPROVEMENT


PARCEL NO: 42-4548-4


111 S. MAPLE AVE. SOUTH SAN FRANCISCO, CA 94080

DRAWING SUBMITTAL SCHEDULE
2024.06.14 MINOR USE PERMIT APPLICATION

PROJECT NO: -

PROPOSED RCP - OFFICE AREA

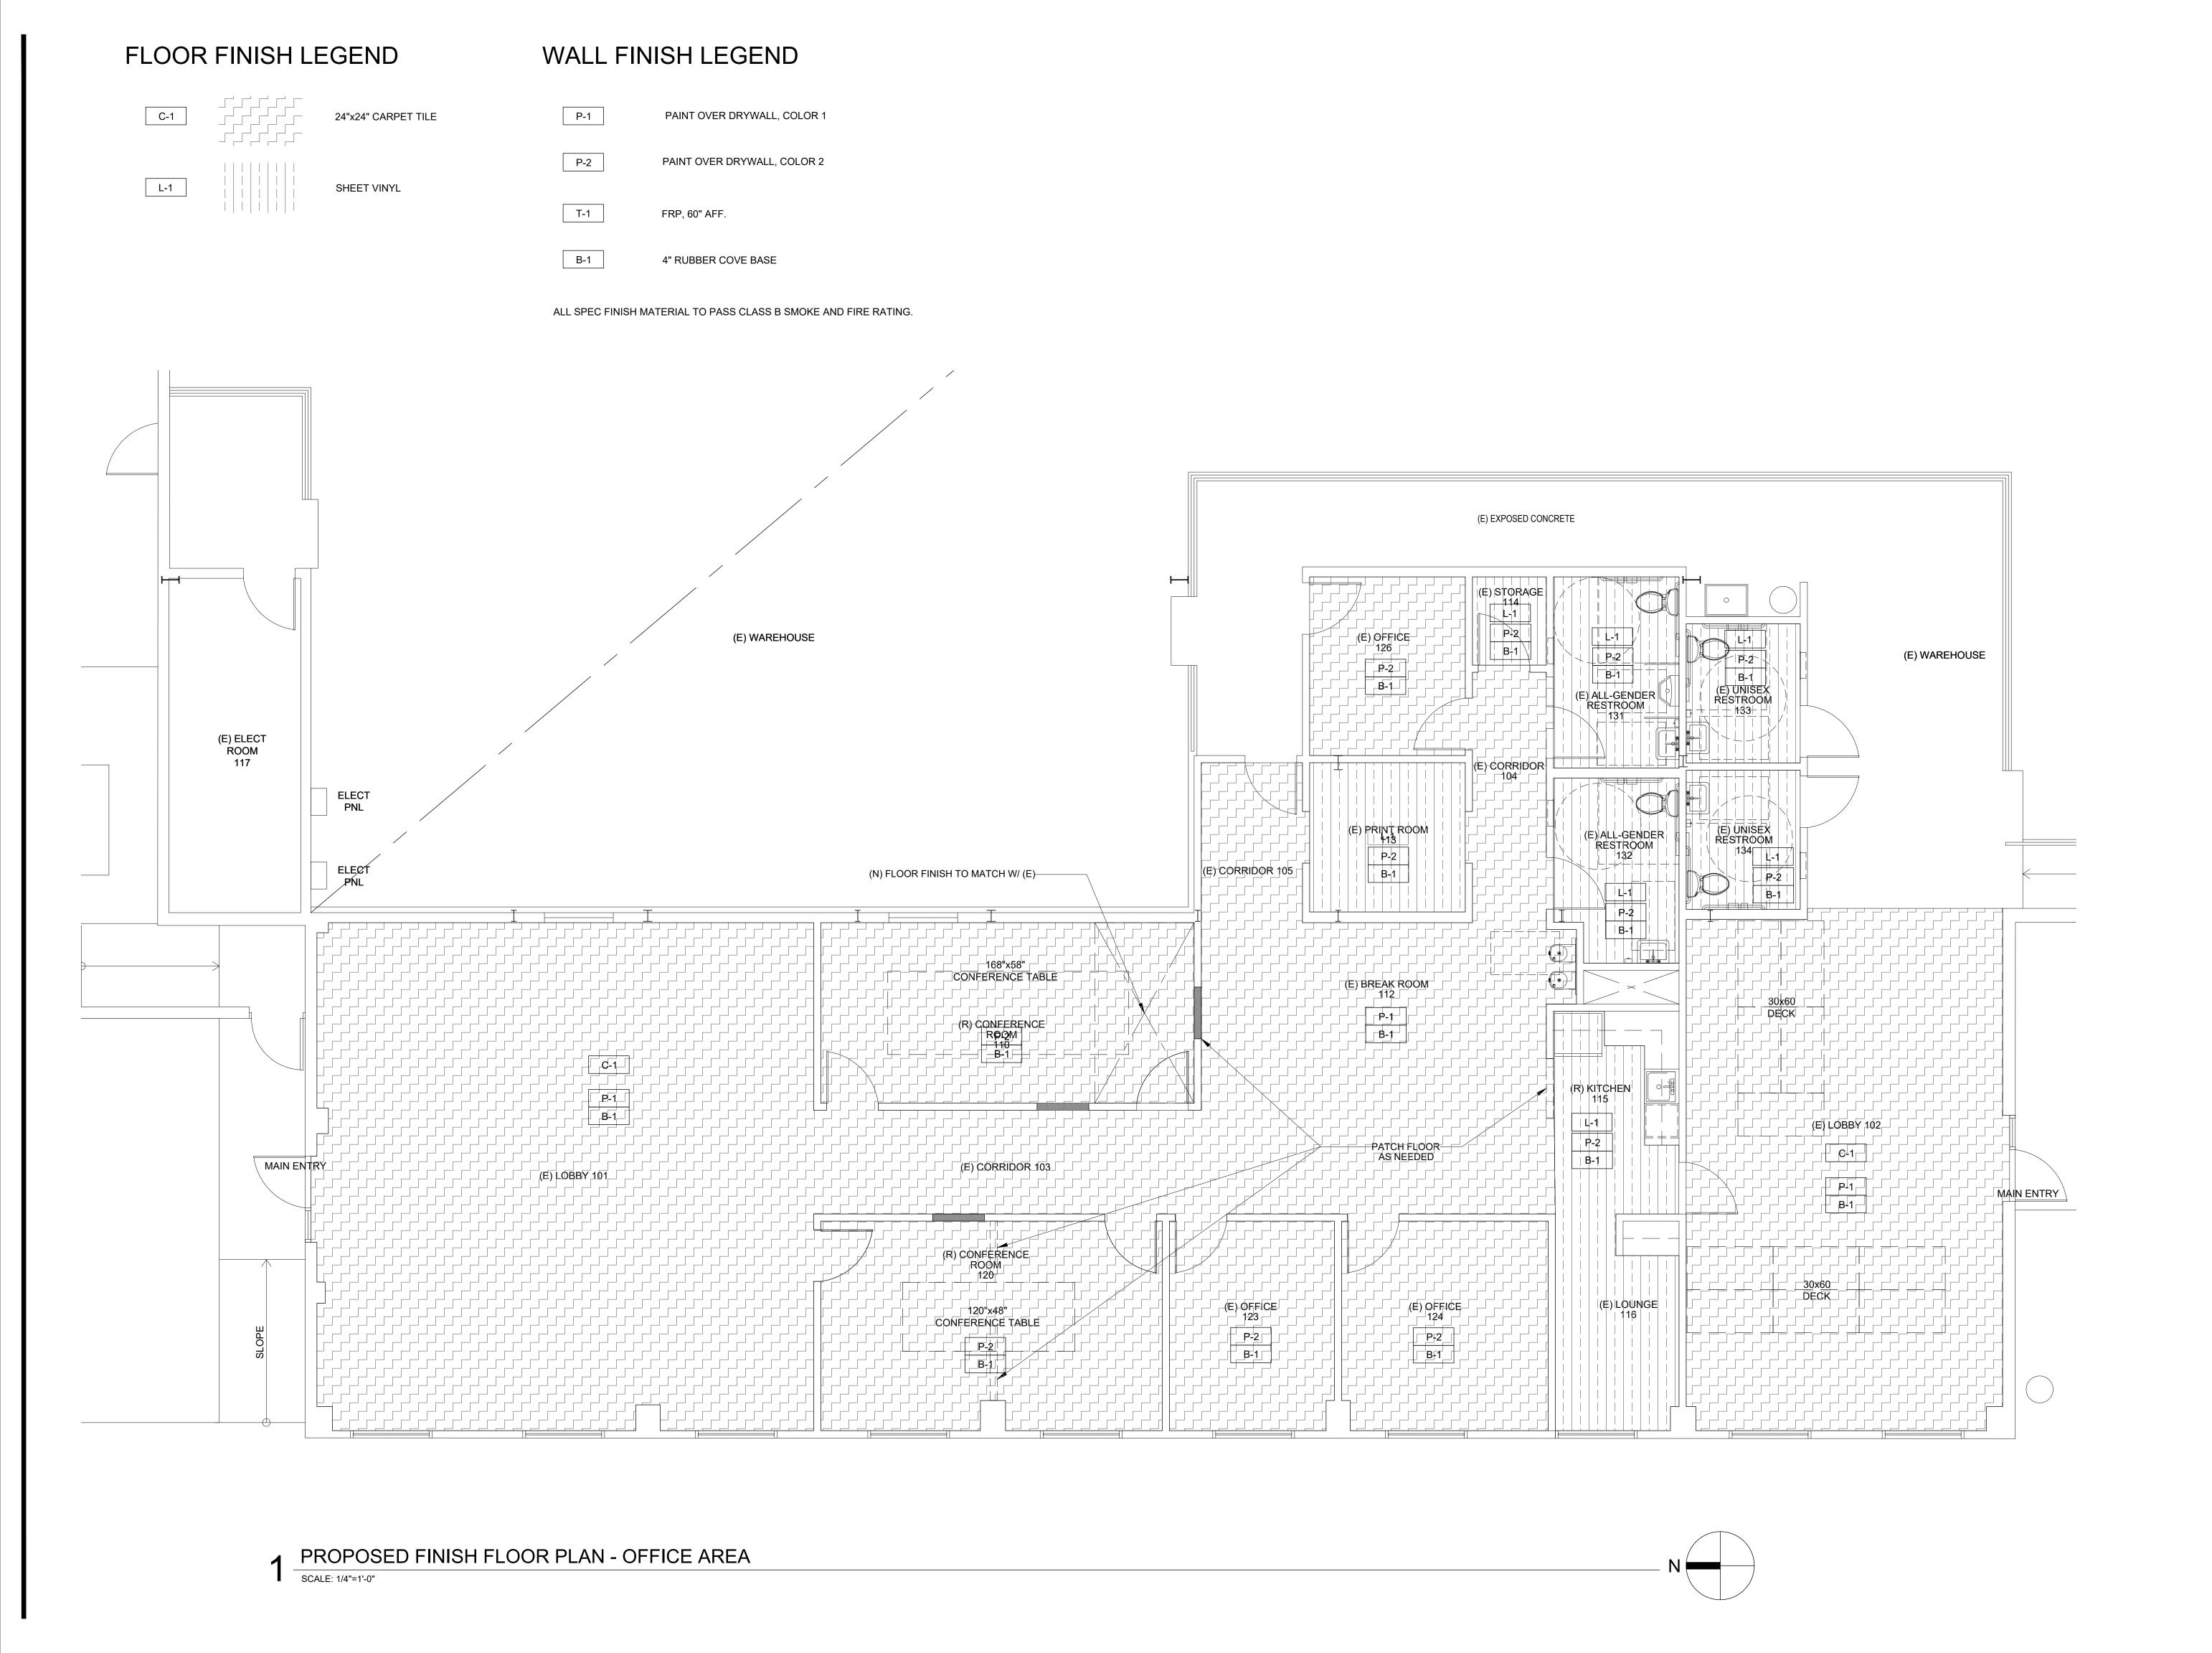

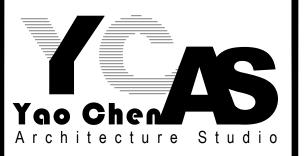

987 CORPORATE WAY, FREMONT, CA 94539 510.613.3223

Email: ychen@ycarchstudio.com

©YCAS 2024

APPLICANT:

C&J CONTRACTING, INC

331 COMMERCIAL ST. SAN JOSE, CA 95112

TENANT & SITE IMPROVEMENT

PARCEL NO: 42-4548-4


111 S. MAPLE AVE. SOUTH SAN FRANCISCO, CA 94080


DRAWING SUBMITTAL SCHEDULE
2024.06.14 MINOR USE PERMIT APPLICATION

PROJECT NO: -

PROPOSED FINISH FLOOR PLAN -OFFICE AREA

LEGEND: **EGRESS CALCULATIONS:** DESIGN OCCUPANT LOAD PER CBC SECTION 1004.1 & TABLE 1004.5 **EMERGENCY EGRESS PATH OF TRAVEL** MEANS OF EGRESS SIZING PER CBC SECTION 1005.1 & 1005.3.2 = OCCUPANT LOAD X 0.2 INCHES CEILING MOUNT INTERIOR LED EXIT SIGN AND LIGHT W/ BATTERY & EMERGENCY LIGHT HEADS EXIT TOTAL OCCUPANT LOAD: 85 85 X 0.2 = 17 INCHES REQUIRED EGRESS 72 INCHES PROVIDED WITH 2 EXIT DOORS AT 36 INCHES. INTERIOR EMERGENCY EXIT LIGHT WITH BATTERY BACK-UP, BATTERY BACK UP DURATION TO BE NOT LESS THAN 90 MINUTES PER CBC 1008.3.4. FOR WAREHOUSE: TOTAL OCCUPANT LOAD: 80 80 X 0.2 = 16 INCHES REQUIRED EGRESS MAX TRAVEL DISTANCE TO EXIT FOR GROUP B, F AND S OCCUPANCY IS 75 FEET.

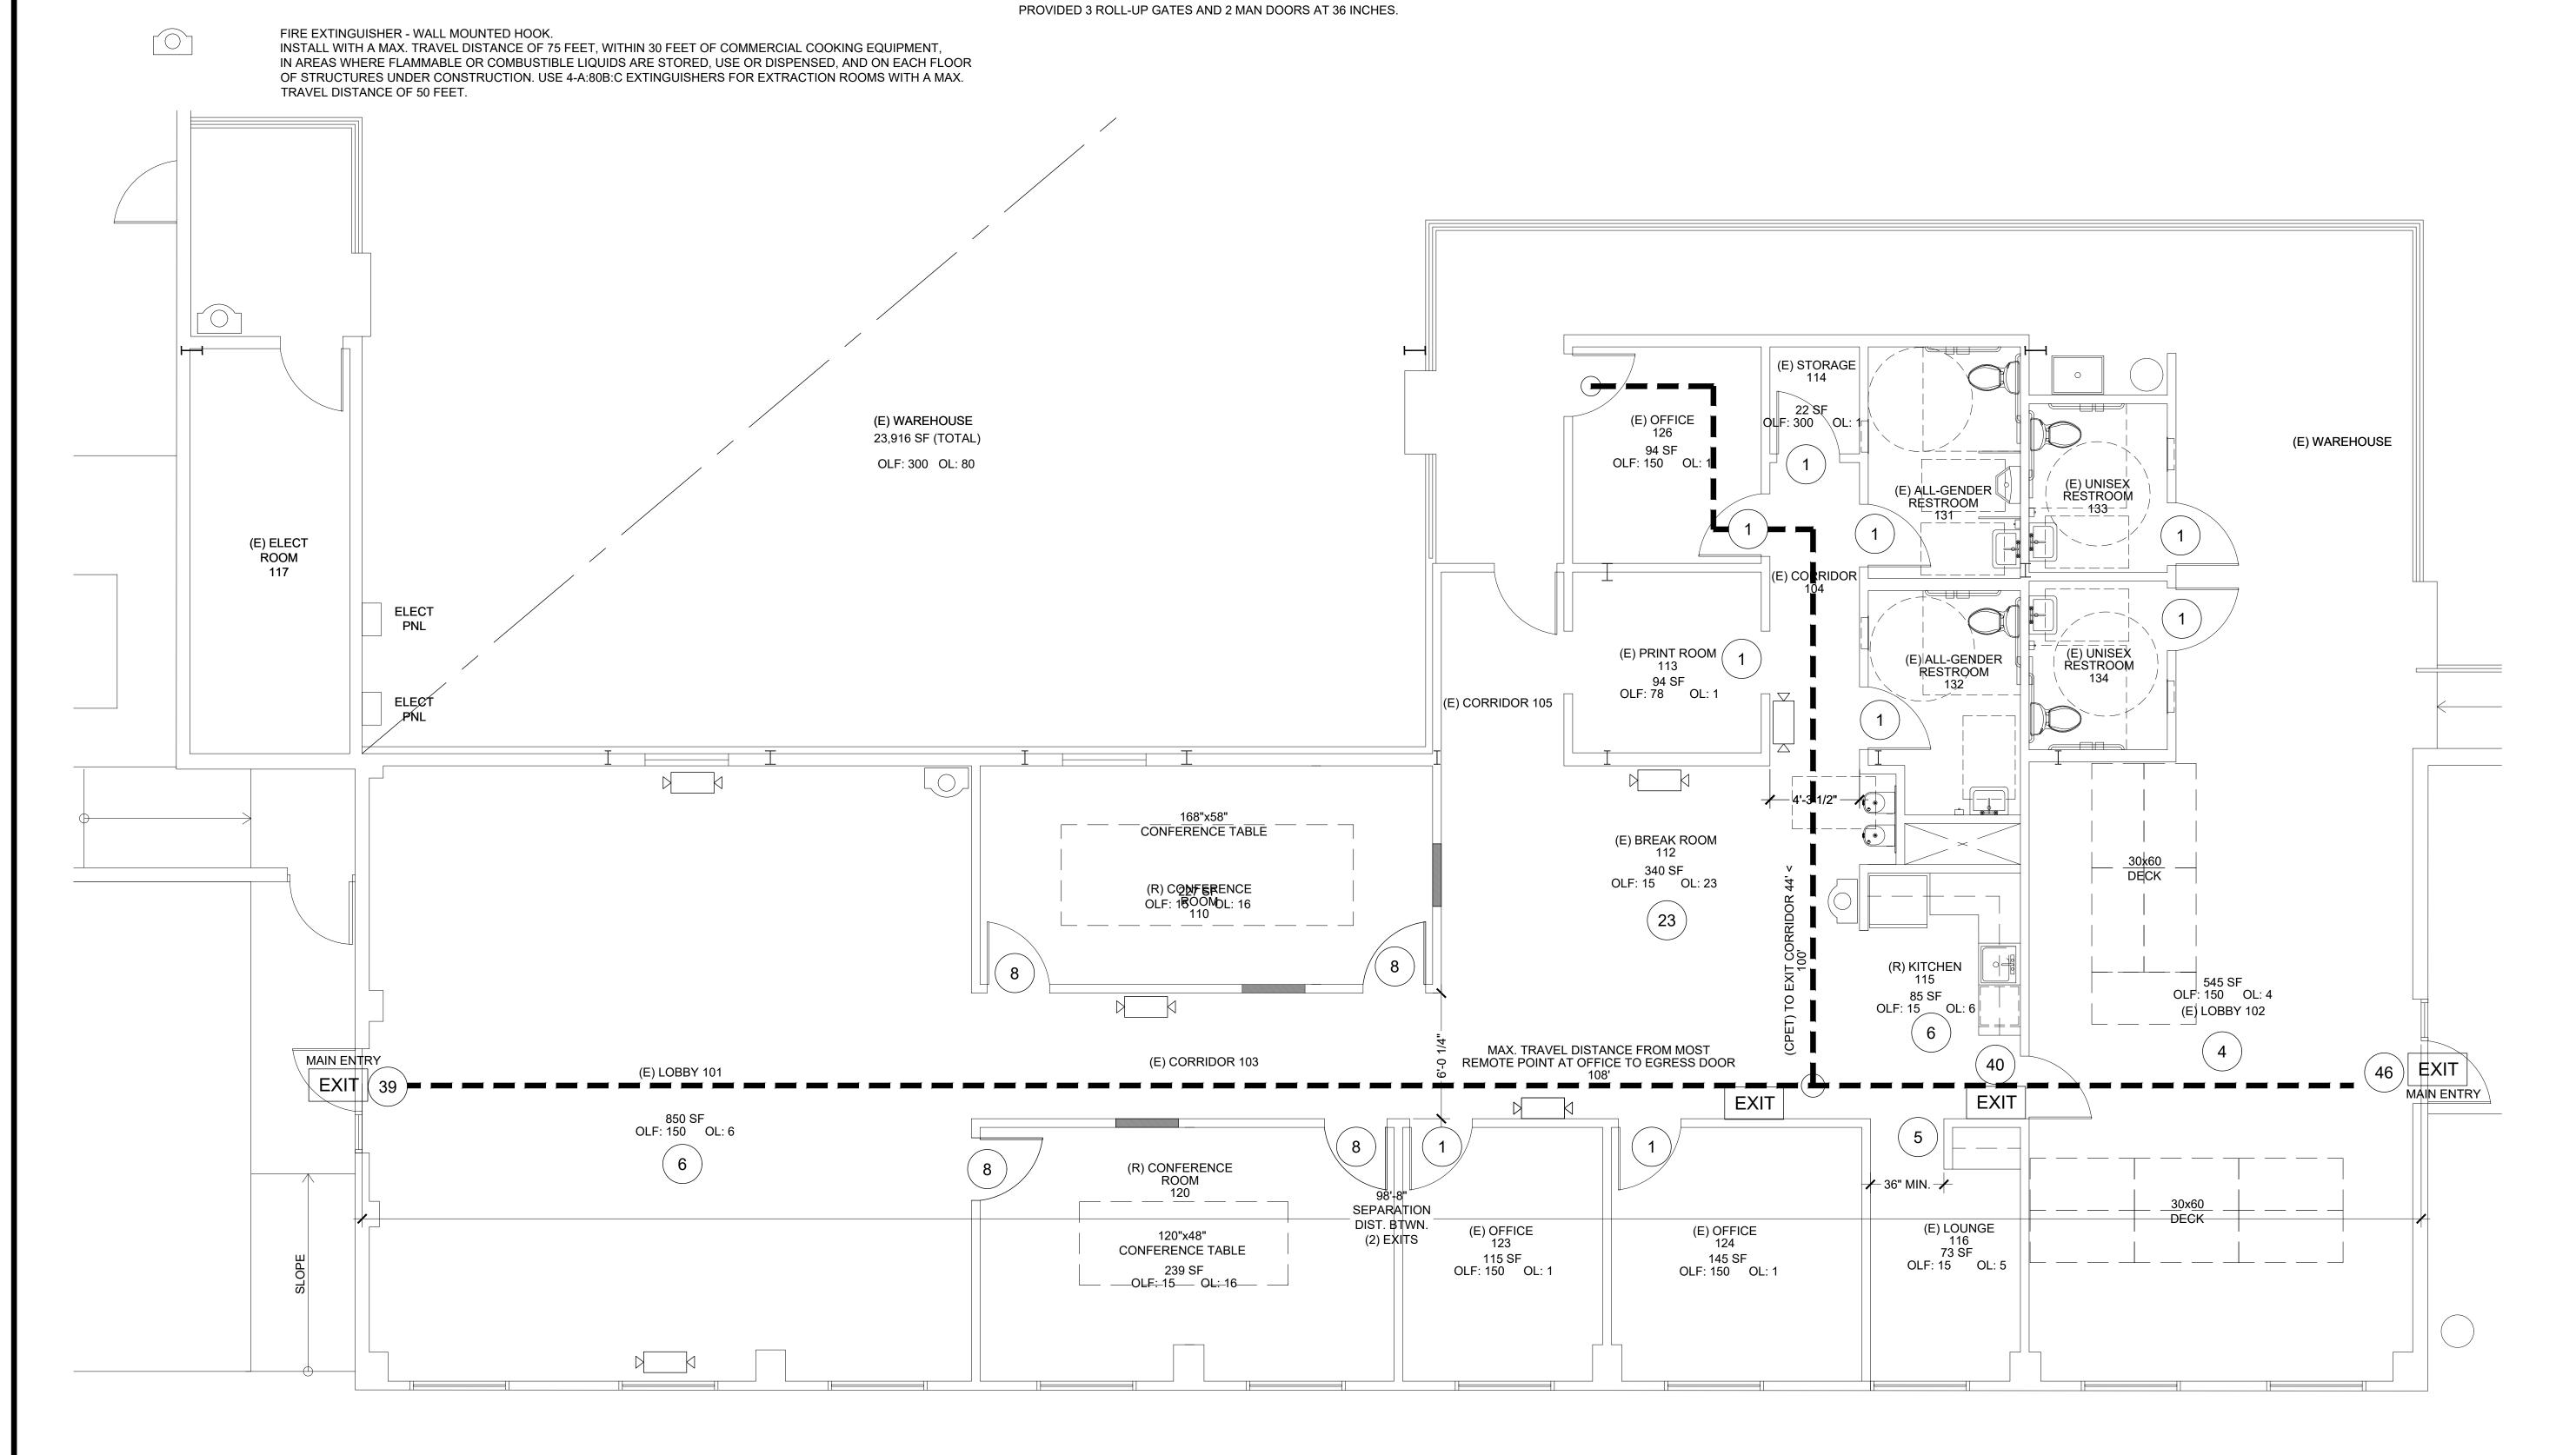

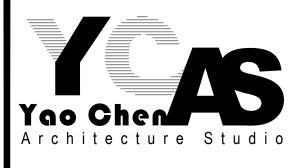

987 CORPORATE WAY, FREMONT, CA 94539 510.613.3223

Email: ychen@ycarchstudio.com

©YCAS 2024

APPLICANT:

C&J CONTRACTING, INC

331 COMMERCIAL ST. SAN JOSE, CA 95112

TENANT & SITE IMPROVEMENT

PARCEL NO: 42-4548-4

111 S. MAPLE AVE. SOUTH SAN FRANCISCO, CA 94080

DRAWING SUBMITTAL SCHEDULE
2024.06.14 MINOR USE PERMIT APPLICATION

PROJECT NO: -

FIRE AND LIFE SAFETY
PLAN

